GENERAL PROJECT NOTES

SUMMARY OF WORK

INTERIOR ALTERATION OF EXISTING 790SF RETAIL SPACE TO A NEW BAKERY SHOP. PROVIDE ALL NECESSARY ARCHITECTURAL, ELECTRICAL, HVAC AND PLUMBING WORK AS NOTED.

GENERAL INSTRUCTIONS

THESE DRAWINGS ARE SCOPE DOCUMENTS INDICATING THE GENERAL PROJECT DESIGN CONCEPT, DIMENSIONS OF THE PROJECT, MAJOR ARCHITECTURAL ELEMENTS, AND BASIC ORGANIZATION OF MECHANICAL, ELECTRICAL AND PLUMBING SYSTEMS. AS SCOPE DOCUMENTS, THESE DRAWINGS DO NOT NECESSARILY DESCRIBE OR INDICATE ALL MATERIALS OR WORK REQUIRED FOR FULL PERFORMANCE AND COMPLETION OF THE PROJECT. ON THE BASIS OF THE GENERAL SCOPE INDICATED OR DESCRIBED, THE CONTRACTOR(S) SHALL FURNISH ALL ITEMS REQUIRED FOR PROPER EXECUTION AND COMPLETION OF THE PROPOSED PROJECT. THE ARCHITECT IS NOT RESPONSIBLE FOR THE FAILURE OF THE CONTRACTOR(S) TO EXECUTE NECESSARY WORK OR TO SUPPLY REQUIRED MATERIALS FOR PROPER COMPLETION OF THIS PROJECT. FURTHER MORE THE ARCHITECT MAKES NO WARRANTY EXPRESSED OR IMPLIED ON THESE DOCUMENTS

DUE TO THE NATURE OF THIS WORK THE ARCHITECT DOES NOT WARRANT THE EXISTING CONDITIONS AS DEPICTED IN THESE DRAWINGS AS BUILT CONDITIONS. THE MEASUREMENTS ON THESE DRAWINGS ARE REASONABLY ACCURATE FOR THE PURPOSE OF "FIGURING." HOWEVER, IN THE EXECUTION OF WORK ON THE JOB, DO NOT SCALE DRAWINGS. EACH CONTRACTOR IS REQUIRED TO VERIFY ALL DIMENSIONS WITH THE ACTUAL CONDITIONS AND TO REPORT ANY DISCREPANCIES TO THE ARCHITECT, OWNER, OR THE OWNER'S REPRESENTATIVE.

CONTRACTOR SHALL OBTAIN AND PAY FOR ANY PERMITS AND FEES REQUIRED TO PERFORM THE WORK, UNLESS DIRECTED OTHERWISE BY OWNER.

EACH CONTRACTOR SHALL BE RESPONSIBLE FOR STORAGE AND SAFETY OF HIS OWN MATERIALS AND WORK, AND FOR PROPERLY REMOVING HIS DEBRIS FROM THE JOB SITE. GENERAL CONTRACTOR (GC) SHALL PROVIDE FOR ALL SITE DEMOLITION AND DEBRIS REMOVAL REQUIRED TO PERFORM NEW CONSTRUCTION WHILE ADEQUATELY MAINTAINING THE PREMISES AND ADJACENT PREMISES TO INSURE NORMAL OCCUPANCY AND SECURITY. THE GC SHALL COORDINATE PROPER TRANSPORTATION AND STORAGE OF BUILDING MATERIALS ON THE SITE TO AVOID OVERLOADING OF EXISTING FLOOR.

CONTRACTORS INSTALLING PIPES, DUCTS AND CONDUIT WILL BE REQUIRED TO DO ALL CUTTING AND PATCHING IN CONNECTION WITH THEIR WORK, INCLUDING EXCAVATION AND DIGGING. THE OWNER WILL ASSUME NO RESPONSIBILITY FOR THE COST OF CHANGES OR EXTRA WORK MADE NECESSARY BY THE FAILURE OF TRADES TO COORDINATE THEIR WORK DURING CONSTRUCTION.

WHERE APPLICABLE THE GC SHALL CONSTRUCT PHYSICAL BARRIERS AROUND AREAS UNDER CONSTRUCTION AS REQUIRED TO ENSURE GENERAL PUBLIC AND PERSONAL SAFETY.

THE GC SHALL SUPERVISE AND DIRECT THE WORK, HE SHALL BE SOLELY RESPONSIBLE FOR ALL CONSTRUCTION MEANS, METHODS. TECHNIQUES, SEQUENCES AND PROCEDURES. THE GC SHALL BE RESPONSIBLE FOR COORDINATING ALL PORTIONS OF THE WORK UNDER HIS CONTRACT. ALL WORK SHALL BE COMPLETED USING PRACTICES ACCEPTED AND ENDORSED BY THE CORRESPONDING TRADE INDUSTRIES.

THE TERM "PROVIDE" SHALL MEAN TO FURNISH AND INSTALL.

THE CONTRACT AND SUBCONTRACT AMOUNTS SHALL PROVIDE COMPLETE WORKING MECHANICAL, ELECTRICAL AND PLUMBING SYSTEMS COMMENSURATE WITH THE REQUIREMENTS OF THE CONTRACT DOCUMENTS AND THE APPLICABLE CODES.

WHEN WALLS ARE TO BE "ALIGNED", THE ALIGNMENT OF SUCH WALLS IS TO THE OUTSIDE FINISHED SURFACE, SUCH AS DRYWALL SURFACE.


ALL DIMENSIONS SHOWN ARE TO FINISH FACE OF WALL UNLESS NOTED OTHERWISE. DIMENSIONS AND NOTES FOR A GIVEN CONDITION ARE TYPICAL FOR ALL SIMILAR CONDITIONS UNLESS NOTED OTHERWISE.

WHERE NEW WORK ADJOINS EXISTING, ALL SUCH NEW WORK SHALL BE PROPERLY INTERGRATED WITH THE EXISTING TO ENSURE UNIFORM APPEARANCE. ANY REPAIR WORK REQUIRED TO EXISTING WORK SHOULD BE TAKEN CARE OF BY THE CONTRACTOR - PROVIDING ALL NECESSARY CUTTING, FITTING AND PATCHING AND SHALL FURNISH ALL NECESSARY LABOR AND MATERIALS FOR THIS WORK. ALL WORK REQUIRING SPECIAL DETAILING, AND NOT DETAILED ON THE DRAWINGS SHOULD BE BROUGHT TO THE ATTENTION OF THE ARCHITECT / OWNER.

THE GENERAL CONTRACTOR SHALL COORDINATE ALL TRADES TO AVOID INTERFERENCE, TO PRESERVE MAXIMUM HEADROOM, AND AVOID OMISSIONS.

THE ARCHITECT HAS NO CONTRACTUAL DUTY TO CONTROL MEANS AND METHODS OF THE WORK NOR TO PROVIDE JOB SITE SUPERVISION, ENSURE SAFETY OR CONSTRUCTION MANAGEMENT AND DOES NOT VOLUNTARILY ASSUME ANY SUCH RESPONSIBILITIES.



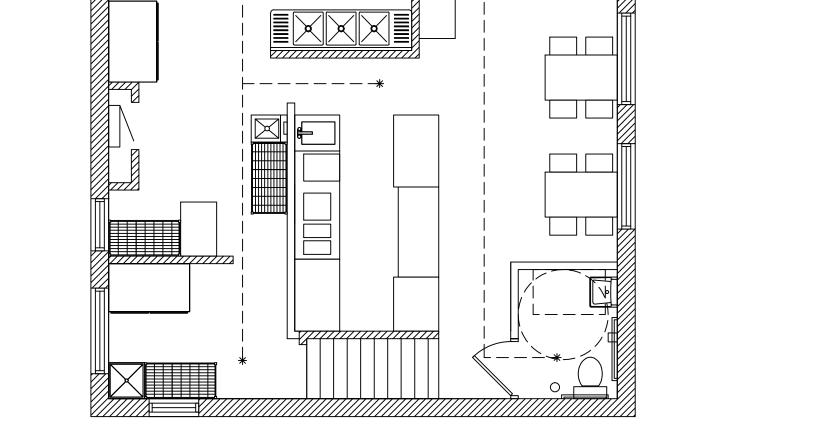

D OCCUPANCY & EXITING DIAGRAM SCALE 3/16"=1'-0"

ACCESSIBILITY REQUIREMENTS

ACCESSIBILE SIGNAGE


TOILET FLUSH VALVE ON OPEN (WIDE) SIDE


___ NOT TO SCALE

IAC 400.310(N)(4)


ACCESSIBILE MOUNTING HEIGHTS

TOILET ROOMS REQUIRED TO BE ACCESSIBLE SHALL CONFORM TO ALL ACCESSIBILITY REQUIREMENTS OF THE AMERICANS WITH DISABILITIES ACT WHICH INCLUDES, BUT IS NOT LIMITED TO THE FOLLOWING:

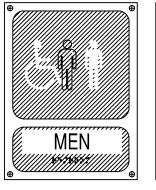

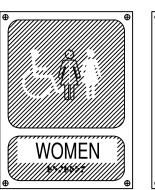



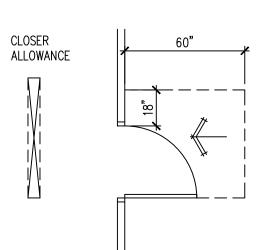


SOAP -DISPENSER

5'-0" TURNING RADIUS

NOT TO SCALE


DOOR MANEUVERING CLEARANCE

—ELEC OUTLET

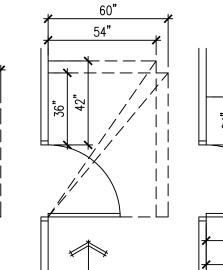


- 18"X36" MIRROR


LEVER STYLE FAUCET AT LAV.

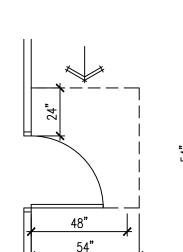

ACCESSIBLE -

SIGNAGE

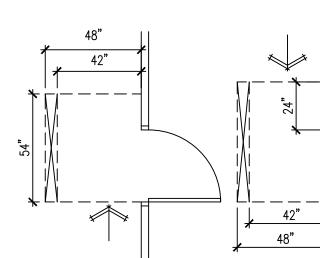

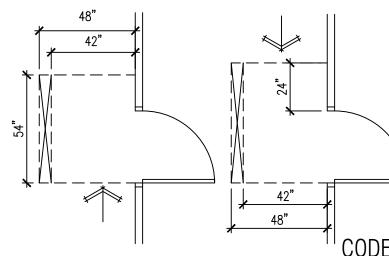

CODE DATA

ALL CONSTRUCTION SHALL BE IN ACCORDANCE WITH ALL APPLICABLE FEDERAL, STATE AND MUNICIPAL LAWS, ORDINANCES, STANDARDS AND REGULATORY AGENCIES INCLUDING BUT NOT LIMITED TO THE REQUIREMENTS (INCLUDING LOCAL AMENDMENTS) OF


2015 INTERNATIONAL BUILDING CODE 2015 INTERNATIONAL FIRE CODE 2015 INTERNATIONAL MECHANICAL CODE 2015 INTERNATIONAL ENERGY CONSERVATION CODE 2014 NATIONAL ELECTRICAL CODE 2014 ILLINOIS STATE PLUMBING CODE 2018 ILLINOIS ACCESSIBILITY CODE LOCAL VILLAGE CODE AMENDMENTS

INDEX OF DRAWINGS

PROJECT NOTES & SITE PLAN FLOOR PLAN, NOTES & SCHEDULES **ELECTRICAL PLAN & NOTES** PLUMBING PLAN & NOTES MECHANICAL PLAN & SCHEDULES

PROJ	ECT DATA	
USE GROUP CLASSIFICATION	A-2	
CONSTRUCTION TYPE	III-B (EXIST'G)	
AREA TOTAL	790SF	
EXIT ACCESS TRAVEL DISTANCE	28 FT MAXIMU	JM
AUTOMATIC SPRINKLERS	NO	
WAITING AREA	180SF /15 =1	2 OCCUPANTS
KITCHEN / SERVICE AREA	(350/200) = 2	OCCUPANTS
TOTAL OCCUPANT LOADS	14 OCCUPAN	ΓS
MAXIMUM HEIGHT	1 STORY	
REQUIRED NUMBER OF EXITS:	1	ACTUAL 2
MINIMUM CORRIDOR WIDTH	36"	

28" EXIT OCCUPANTS = 12

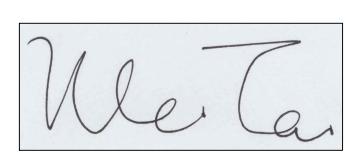

I HEREBY CERTIFY THAT THESE DRAWINGS ARE PREEPARED BY ME OR UNDER MY SUPERVISION AND TO THE BEST OF MY KNOWLEDGE CONFORM WITH APPLICABLE CODES.

LIC EXPIRES NOV 30, 2022

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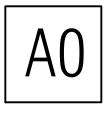
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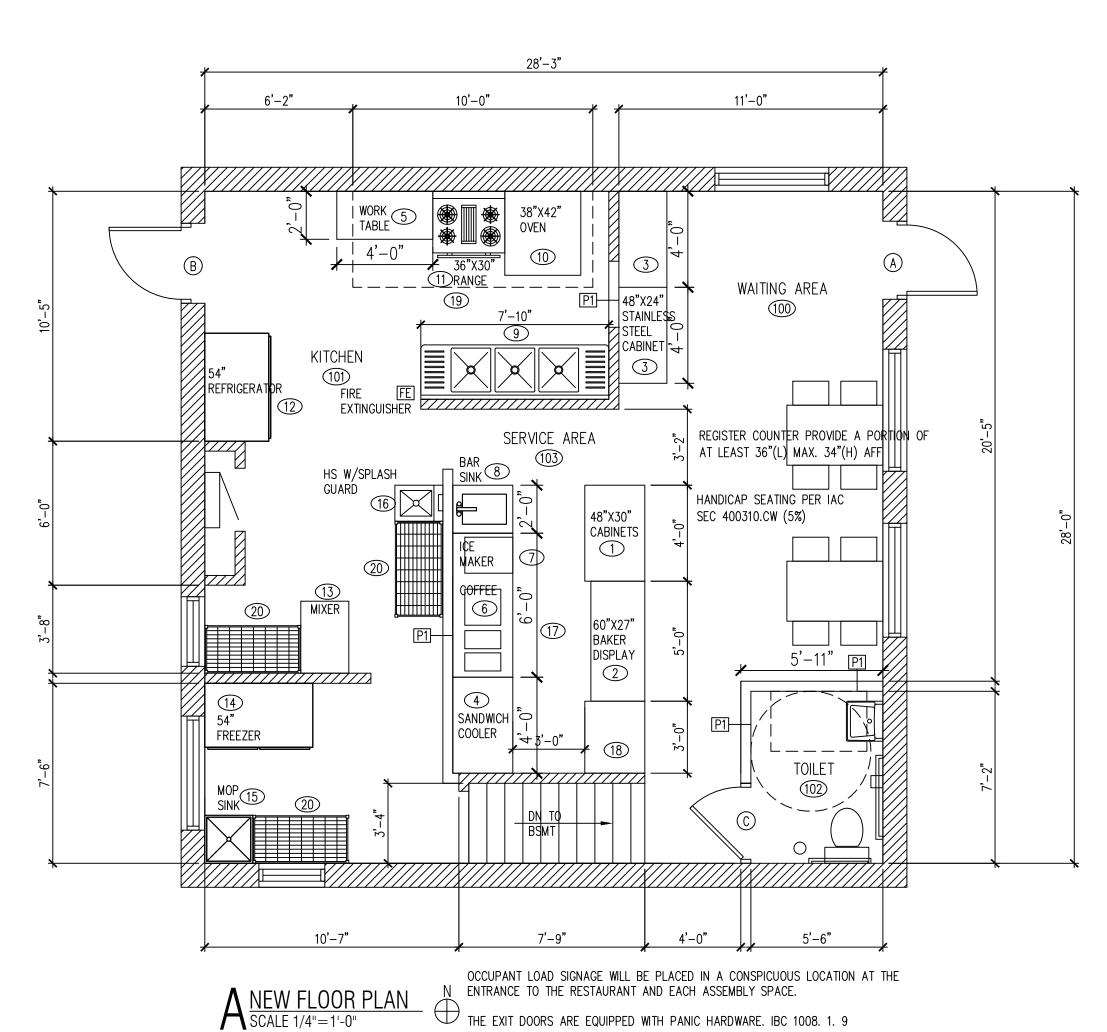
PROJECT NOTES, SITE PLAN

SHEET NUMBER





- LAVATORY



EMERGENCY AND GENERAL EGRESS DISCHARGE LIGHTING. IBC 1006.1 ON SHEET E2

DOOR SCHEDULE FRAME CONSTRUCTION NOMINAL SIZE DOOR FINISH DESCRIPTION FRAME FINISH LABEL HARDWARE SET COMMENTS STORE FRONT GLASS DOOR 3'-0" x 7'-0" TEMPERED GLASS EXIST'G FRONT EXIT DOOR B HOLLOW METAL DOOR 3'-0" x 7'-0" PAINT HOLLOW METAL EXIST'G BACK EXIT DOOR 3'-0" x 7'-0" PAINT PAINT WOOD DOOR HOLLOW METAL * ALL EXIT DOORS MUST OPEN WITHOUT THE USE OF A KEY OR SPECIAL KNOWLEDGE FROM THE SIDE WHICH EGRESS IS MADE * LEVERED HANDLE HARDWARE AS REQUIRED BY ILLINOIS ACCESSIBILITY CODE * PROVIDE DOOR CLOSERS ALONG ALL ACCESSIBLE ROUTES

	EQUIPMENT SCHEDULE								
NO	QTY	DESCRIPTION	GAS	ELEC	CTRIC	PLUMBING	REMARKS		
1	1	48"X30" STAINLESS STEEL CABINET	-	-	_	_	NSF		
2	1	60"X27" BAKER DISPLAY	-	120V	4A	_	NSF		
3	3	48"X24" STAINLESS STEEL CABINET	-		_	_	NSF		
4	1	SANDWICH PREP COOLER	-	120V	5A	_	NSF		
5	1	48"X24" WORK TABLE	-	=1	=1	-	NSF,W/ 6" STAINLESS STEEL LEGS NSF APPROVED		
6	1	COFFEE MAKER	-	120V	H	<u>-</u>	NSF		
7	1	UNDERCOUNTER ICE MAKER	-	120V	5A	3/8" CW	NSF,AIR COOLED CONDENSING UNIT		
8	1	PREP SINK	-	-	_	1/2" CW,1/2" HW, 4" INDIRECT DRAIN	NSF		
9	1	3 COMPARTMENT SINK	-	-	-	1/2"CW,1/2" HW, 4" INDIRECT DRAIN	NSF,W/ ECOLAB PATHWAY TO PREVENT BACKFLOW		
10	1	38"X42" OVEN	3/4"	120V	_	-	NSF		
11	1	36"X30" RANGE	3/4"	120V	-	-	NSF		
12	1	54" REFRIGERATOR	-	120V	5A	-	NSF		
13	1	DOUGH MIXER	~	220V	3000W	=	NSF		
14	1	54" FREEZER	-	120V	5A	-	NSF		
15	1	MOP SINK	-	_	_	1/2"CW,1/2" HW, 4" DRAIN	NSF, W/ MOP HOOKS, SEAL EDGES		
16	1	HAND SINK	-	-	_	1/2" CW,1/2" HW, 2" DRAIN	NSF, WALL MOUNTED - SEALED		
17	1	72"X30" STAINLESS STEEL CABINET	-	-	-	-	NSF		
18	1	36"X30" STAINLESS STEEL CABINET	-	-	_	-	NSF		
19	1	EXIST'G 10'-0"X4'-0" TYPE II HOOD	-	-	-	-	NSF		
20	3	48"X24" STAINLESS STEEL SHELVING	-	-	-	-	NSF		
ALL	EQUIPI	MENTS WILL BE NSF APPROVED CLEAN,OF	PERABLE AN	D SUBJECT	T TO THE FINAL APPROVA	L BY THE HEALTH			

COOKLINE EQUIPMENT AND REACH-IN REFRIGERATION AND FREEZER UNITS TO BE INSTALLED ON CASTERS. PROVIDE THE FOLLOWING: NSF STAINLESS STEEL SHELF OVER 3-COMPTMENT SINK. ICE MAKER A MIN. 8" FROM ALL WALLS. HEAVY-DUTY MOP RACKS LOCATED OVER MOP SINK. HEAVY-DUTY BROOM RACKS IN JANITORIAL AREA. METAL GARBAGE CANS WITH LIDS FOR RESTROOMS.SANITARY BOX IN WOMEN'S RESTROOMS. METAL GARBAGE CANS WITH LIDS FOR DIAPER CHANGING STATION.

ALL NSF APPROVED HAND SINKS TO BE WITH BLADE HANDLED FAUCETS. WAITRESS, BEVERAGE STATION & BAR COUNTER TOP -STAINLESS STEEL ALL CABINET SHELVES -STAINLESS STEEL.

DEPARTMENT


ALL CABINET BASE - 6" STAINLESS STEEL LEGS (NO KICK BASE)

LAVATORY COUNTERTOP TO BE SOLID SURFACE (NO PLASTIC LAMINATE OR CABINETRY)

ANY PAINTED FINISHES TO BE SEMI-GLOSS OR GLOSS (NO FLAT, NO EGG SHELL, NO TEXTURE),

PROVIDE FRP ON WALL AND UNDERSIDE OF BAR.


STAINLESS STEEL WALL FINISH FOR BEHIND AND ADJACENT TO COOK LINE

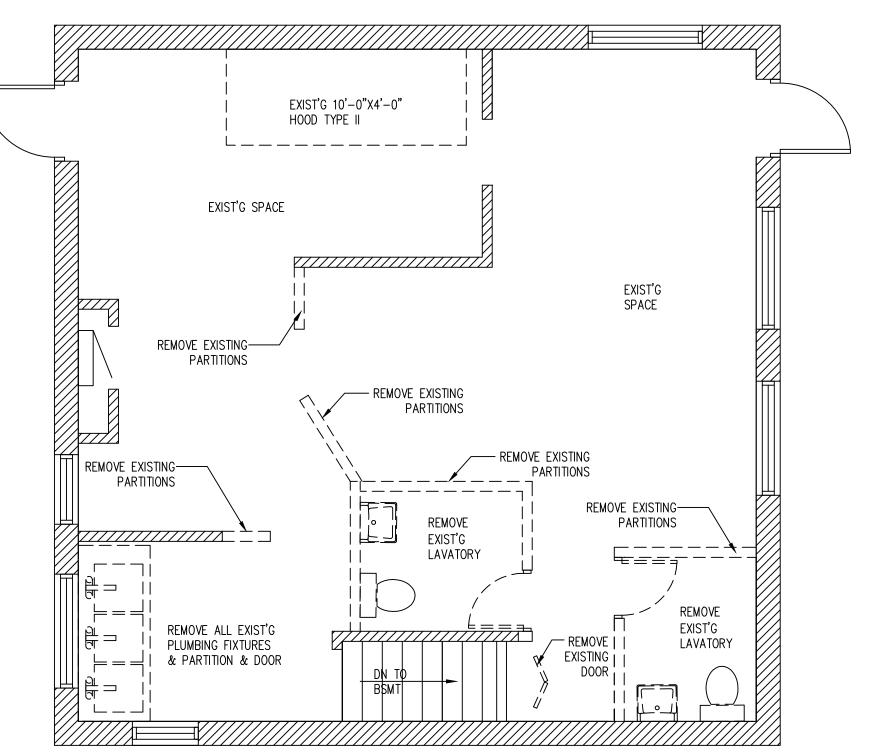


FIRE EXTINGUISHERS TO BE TYPE K IN KITCHEN

AND TYPE A IN WAITING ROOM

B DEMO PLAN SCALE 1/4"=1'-0" EXISTING WALL TO REMAIN DEMO WALL []

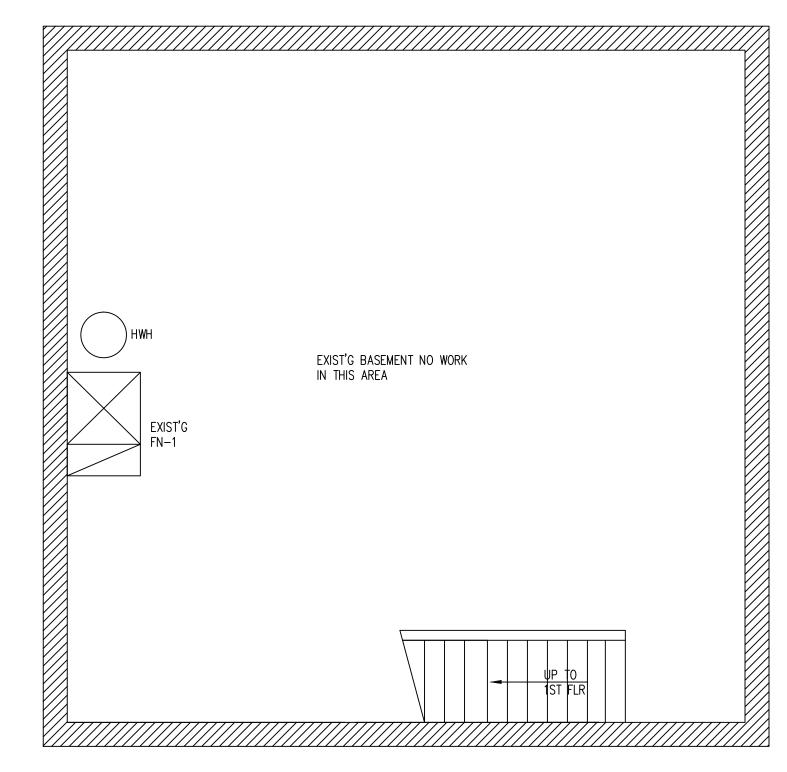



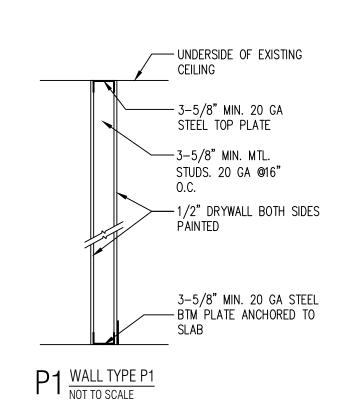

	ROOM FINISH SCHEDULE								
NO	ROOM	WALLS	BASE	FLOOR	CEILING				
100	WAITING AREA	GYP. BD. PAINTED	QT COVE BASE	FLOOR TILE	EXIST'G GYP BD PAINTED				
101	KITCHEN	STAINLESS STEEL	QT COVE BASE	QUARRY TILE	EXIST'G GYP BD PAINTED				
102	TOILET	GYP. BD. PAINTED	QT COVE BASE	FLOOR TILE	EXIST'G GYP BD PAINTED				
103	SFRVICE AREA	STAINLESS STEEL	OT COVE BASE	OUARRY TILF	FXIST'G GYP BD PAINTED				

KITCHEN EQUIPMENT NOTES

CONTRACTOR SHALL INSTALL AND CONNECT ALL EQUIPMENT AS PER EQUIPMENT SUPPLIER'S SPECIFICATIONS. ALL LOCATIONS TO BE VERIFIED WITH OWNER PRIOR TO INSTALLATION.

PLUMBING CONTRACTOR SHALL PROVIDE ALL ROUGH-INS. INSULATE ALL COLD/HOT WATER PIPES AS REQUIRED. MAINTAIN MIN 36" IN FRONT OF ALL COOKING EQUIPMENT.

ELECTRICAL CONTRACTOR SHALL PROVIDE ALL ELECTRICAL OUTLETS FOR EQUIPMENT. VERIFY ALL ELECTRICAL REQUIREMENTS WITH EQUIPMENT SUPPLIER. VERIFY ALL GAS AND WATER REQUIREMENTS WITH EQUIPMENT SUPPLIER.

ALL PERMANENT EQUIPMENT MUST BE LOCATED SO THAT AREAS BEHIND, UNDERNEATH, AND ON THE SIDES OF THE EQUIPMENT CAN BE EASILY CLEANED.

TWO DRAIN BOARDS ARE REQUIRED AT ALL THREE-COMPARTMENT SINKS ALONG WITH AN APPROPRIATELY SIZED FAUCET, LOCKABLE DRAIN PLUGS, AND AN INDIRECT CONNECTION TO THE SEWER.

DRY STORAGE

DRY STORAGE: 25% OF 324SF (KITCHEN AREA.)=81SF REQ'D ACTUAL DRY STORAGE 3X4X4X2 = 96SF PROVIDED.

ALL FOOD AND FOOD RELATED ITEMS MUST BE STORED OFF THE FLOOR ON DURABLE WASHABLE SHELVES. THE STORAGE AREA MUST BE APPROPRIATELY SIZED BASED ON THE NUMBER OF MEALS SERVED DAILY AND THE NUMBER OF DELIVERIES WEEKLY.

ALL FOOD EQUIPMENT TO BE ON CASTERS, 6" LEGS, OR SEALED TO THE FLOOR FOR EASY CLEANING.

NO RAW WOOD SURFACES PERMITTED ANYWHERE. UNDERSIDES OF COUNTERTOPS, INSIDE OF CABINETRY, AND WATER HEATER PLATFORMS MUST BE SEALED.

• Dial stem thermometers (ranging from 0° to 220°F) are required in all preparation areas.

Chemical test kits (specific to the sanitizer) are required for the appropriate sanitizer.

pH meter and log for acidifying rice.

All cooling/freezing units must have accurate thermometers.

Covered waste cans are required in all restrooms.

 Toilets, urinals, hand sinks, 3 compartment sinks, mop sink, prep sinks, and permanent counters/cabinets must be sealed to floors and walls with a silicone caulk seal.

Anti-siphon devices are required on all toilet tanks, urinals, and faucets with hose

Soap and paper towels are required at all hand sinks.

Provide hair restraints and disposable gloves for all food handlers.

If sinks are provided with spring-loaded faucets, the faucets must remain running for a minimum

Doors leading to the outside and restroom doors are required to be self-closing and tight-fitting Please confirm that the doors leading to the outside are equipped with a self-closer and weather strips to eliminate any air gaps.

HARDWARE SCHEDULE							
TAG	DESCRIPTION						
1	3 HINGES, W/LEVERED PRIVACY LOCKSET , KICKPLATE AND DOOR CLOSER						
2	PADDLE LATCH EXIT DEVICE AND DOOR CLOSER, PANIC HARDWARE						

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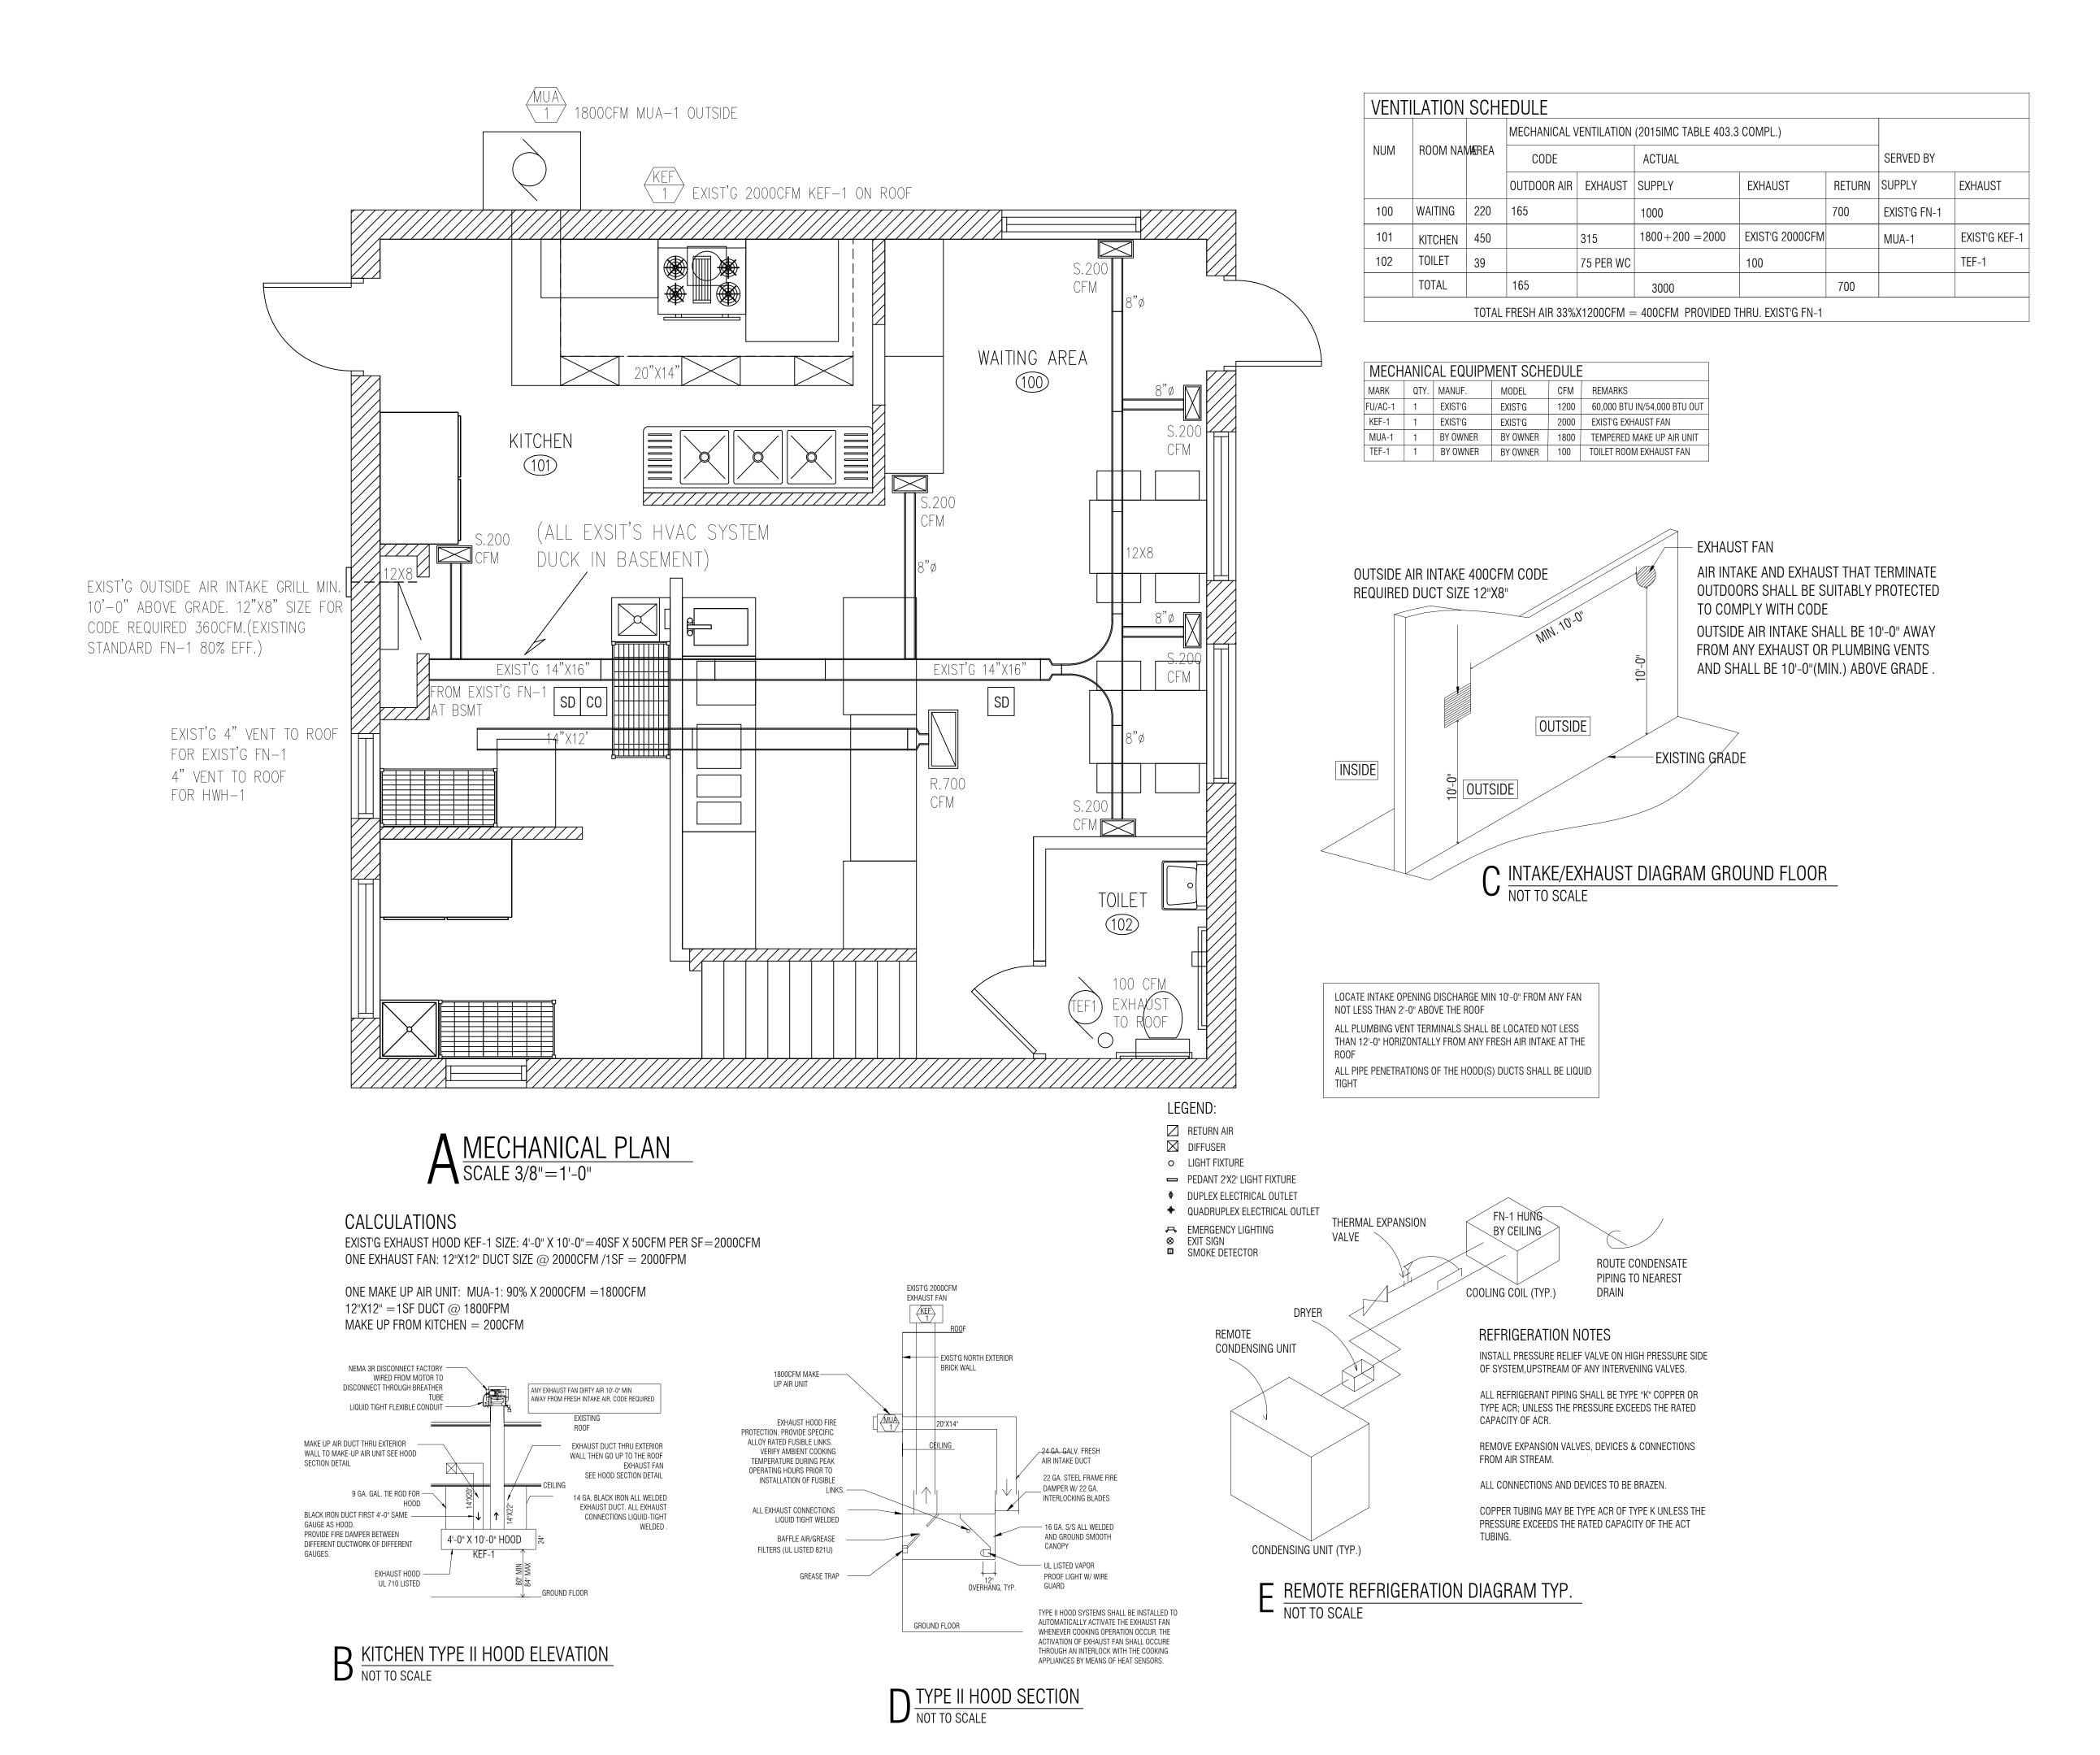
ISSUES	DATE
ISSUED FOR PERMIT	02/12/2021



FLOOR PLAN, NOTES, & **SCHEDULES**

SHEET NUMBER





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> INTERIOR REMODELING 300 NORTH LAKE STREET MUNDELEIN IL 60060


ISSUES	DATE
ISSUED FOR PERMIT	02/14/2021



MECHANICAL PLAN & NOTES

SHEET NUMBER

| 1/1

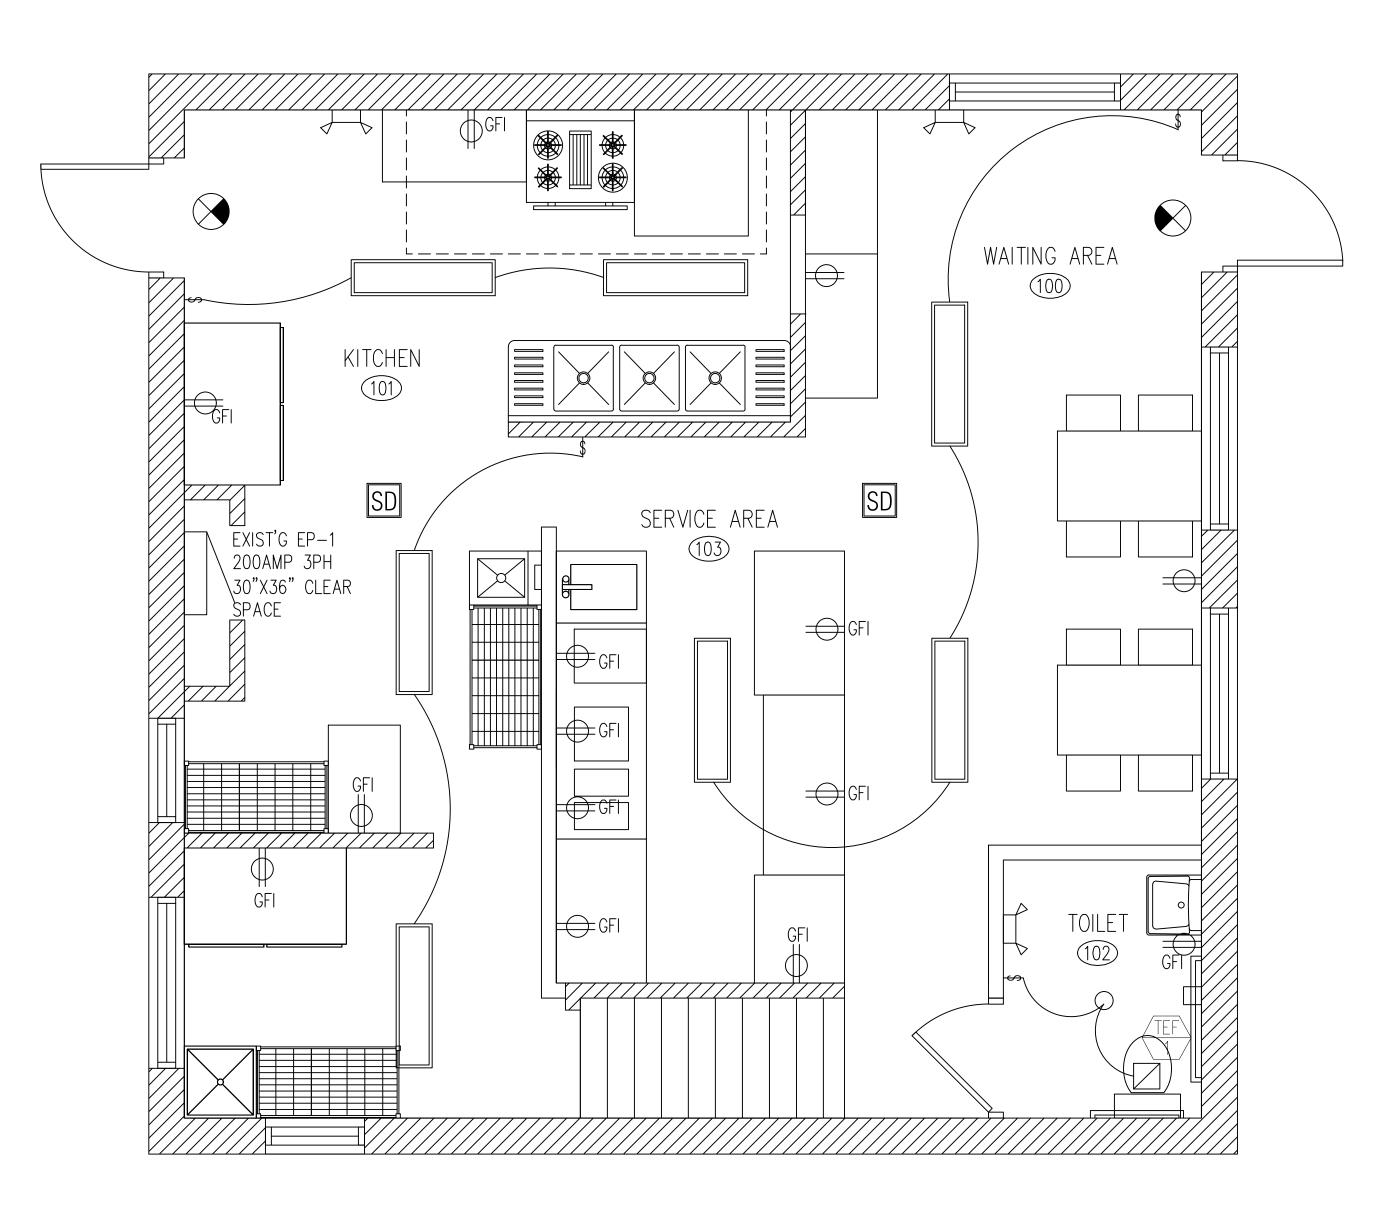

A ELECTRICAL PLAN SCALE 3/8"=1'-0"

EMERGENCY LIGHT FIXTURE SCHEDULE								
TYPE	MANUFACTURER	MODEL	LAMP	DESCRIPTION				
7	SURE-LITES	XR-9-C	(2)HALOGEN 12W	PPROVED BATTERY EM FIXTURE				
\otimes	ALPHA	EM-C SERIES	(2)7W FLUORESCENT	APPROVED SINGLE FACE EXIT SIGN				
		SINGLE FACE		BATTERY BACKUP 120V FIXTURE				

FIRE PREVENTION BUREAU EXIT SIGN SYMBOLS

⊗#3 SINGLE FACE EXIT SIGN SINGLE FACE EXIT SIGN
W/DIRECTIONAL ARROW

VIEW SIDE OF FIXTURE
W/DIRECTIONAL ARROW

W/DIRECTIONAL ARROW

W/DIRECTIONAL ARROW

W/DIRECTIONAL ARROW

W/DIRECTIONAL ARROW

LEGEND:

RETURN AIR

DIFFUSER

LIGHT FIXTURE

RECESSED 2'X4' LIGHT FIXTURE

EMERGENCY LIGHTING

EXIT SIGN

SMOKE DETECTOR

LIGHTING NOTES

AT LEAST FIFTY (50) FOOT CANDLES OF LIGHT SHALL BE PROVIDED ON ALL WORKING SURFACES. THIRTY (30) CANDLES OF LIGHT SHALL BE PROVIDED ON FOOD PREPARATION EQUIPMENT, UTENSIL WASHING SINKS, HAND WASHING AREAS RESTROOMS, AND ALL OTHER SURFACES. TWENTY (20) FOOT CANDLES OF LIGHT, AT A DISTANCE OF THIRTY (30) INCHES FROM THE FLOOR, SHALL BE PROVIDED IN ALL OTHER AREAS.

SHIELDING TO PROTECT AGAINST BROKEN GLASS FALLING IN FOOD SHALL BE PROVIDED FOR ALL LIGHTING FIXTURES LOCATED IN FOOD STORAGE, PREPARATION, SERVICE AND DISPLAY AREAS, AS WELL AS WHERE UTENSILS AND EQUIPMENT ARE CLEANED AND STORED. TEFLON COATING REQUIRED ON EXPOSED BULBS IN BARS AND WAIT STATIONS.

ALL OUTSIDE LIGHTING TO REMAIN. AT LEAST FIFTY (50) FOOT CANDLES OF LIGHT SHALL BE PROVIDED ON ALL WORKING SURFACES. THIRTY (30) CANDLES OF LIGHT SHALL BE PROVIDED ON FOOD PREPARATION EQUIPMENT, UTENSIL WASHING SINKS, HAND WASHING AREAS RESTROOMS, AND ALL OTHER SURFACES. TWENTY (20) FOOT CANDLES OF LIGHT, AT A DISTANCE OF THIRTY (30) INCHES FROM THE FLOOR, SHALL BE PROVIDED IN ALL OTHER AREAS.

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ALL DROP/PLENUM CEILING WIRING TO COMPLY WITH NEC 300.22C. ALL LOW VOLTAGE WIRING TO BE SELF SUPPORTING. NOT RUN OVER ANY LIGHT BALLAST, AND RUN 90 DEGREE.

ALL FIRE ALARM, SMOKE DETECTOR, NIGHT LIGHT, AND EXIT SIGN CIRCUITS SHALL BE SECURED WITH A LOCKOUT DEVICE TO PREVENT ACCIDENTAL DEACTIVATION. INTERLOCK MOTORIZED DAMPERS MUST BE INSPECTED AT ROUGH AND FINAL STAGES BY BOTH THE ELECTRICAL AND MECHANICAL INSPECTORS.

INTERLOCK MOTORIZED DAMPERS MUST BE INSPECTED AT ROUGH AND FINAL STAGES BY BOTH THE ELECTRICAL AND MECHANICAL INSPECTORS. ALL LOW VOLTAGE WIRING FOR MECHANICAL HVAC (DDC) CONTROLS AND ANY AND ALL OTHER USES MUST BE RUN AT RIGHT 90 DEGREE ANGLES AND PROPERLY SUPPORTED. NO LOW VOLTAGE WIRING MAY CROSS OVER CEILING LIGHT FIXTURES.

EXHAUST FAN CONTROL SWITCHES MUST HAVE A PILOT LIGHT INDICATING FAN MOTOR IS POWERED. TIMERS ARE NOT APPROVED IN THE VILLAGE FOR EXHAUST FAN OPERATIONS OR THE OPERATIONS OF ANY MECHANICAL EQUIPMENT.


ALL RECEPTACLES SHALL BE RATED AT NO LESS THAN 20 AMPS WITH #12 COPPER WIRE

STORAGE BATTERIES FOR POWERING EMERGENCY SYSTEM SHALL BE OF SUITABLE RATING AND CAPACITY TO SUPPLY AND MAINTAIN THE TOTAL EMERGENCY LOAD FOR A PERIOD OF 1.5 HOURS MINIMUM WITHOUT THE VOLTAGE APPLIED TO THE LOAD FALLING BELOW 87.5% OF NORMAL

ALL OUTLETS ABOVE COUNTERTOPS SHALL BE INSTALLED WITH LONG DIMENSION OF THE PLATES HORIZONTAL PROVIDE KELLUM GRIP (WIRE MESH SPRING RELIEF) AT ALL CEILING RECEPTACLE DROPS MAINTAIN 36" CLEAR FLOOR SPACE IN FRONT OF PANELS.

FINAL LOCATIONS OF TELEPHONE AND DATA OUTLETS TO BE CONFIRMED BY OWNER

ELECTRICAL 125V CONVENIENCE OUTLETS SHALL BE LOCATED ON THE SAME LEVEL WITHIN 25' OF ROOF MOUNTED EQUIPMENT.

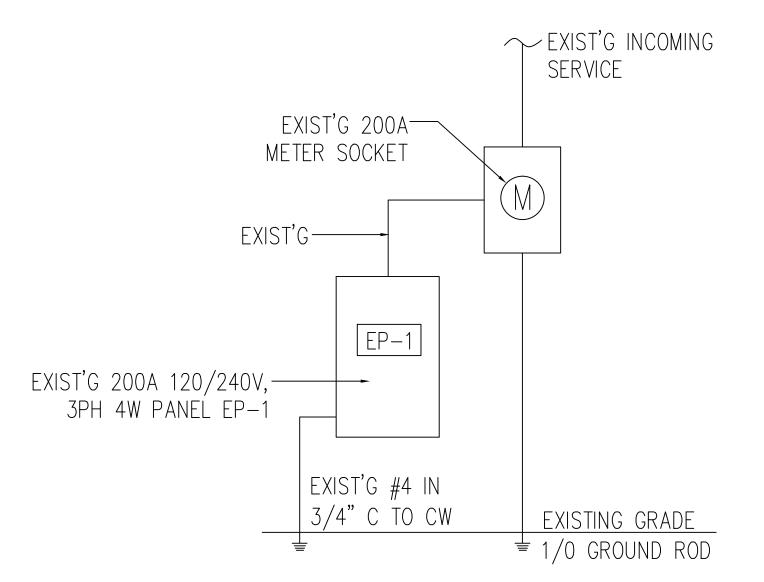

B EXISTING POWER DISTRIBUTION DIAGRAM NOT TO SCALE

				EXIST'S	200A	110/	240V, 3PI	H EP-1			
SERVES	С	В	А	AMPS	СК	CK	AMPS	Α	В	С	SERVES
ICE MAKER	1800		1222	20	1	2	15	180			FURANCE
SIGN OUTLET		1200	1222	20	3	4	15		350		EMERGENCY LIT
SANDWICH COOLER			1200	20	5	6	15			350	WAITING RM LIT
FREEZER	1500			20	7	8	15	350			KITCHEN LIT
REFRIGERATOR		1500		20	9	10	20		1200		BAKERYDISPLAY
WAITING OUTLET			1080	20	11	12	20			1200	COFFEE MAKER
KITCHEN OUTLET	1080			20	13	14	20	1800			OVEN
BASEMENT LITS		700		15	15	16	2		1800		OVLIV
BASEMENT OUTLETS			720	20	17	18	30			2880	DOUGH MIXER
KITCHEN OUTLET	1080			20	19	20	2	2880			DOGGITIVIIALIT
WORK TABLE OUTLET		1080		20	21	22	80		7680		SUB PANEL
TOILET RM OUTLET			1200	20	23	24	2			7680	OODITAINEE
BASEMENT OUTLETS	720			20	25	26	20	360			REGISTER OUTLET
MUA-1		2100		30	27	28	20			1800	EXIST'G KEF-1
IVIO/X 1			2100	2	29	30	2	1800			EMOT WILL T
					31	32					
					33	34					
					35	36					
					37	38					
					39	40					
SUBTOTAL	6180	6580	6300					7370	11030	13910	
TOTAL PANEL LOAD	51370	VA	142.7	AMPS 3 PH	ASE						

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LICENSE NO: 001-022013 EXPIRES: 11/30/2022

MEP ENGINEER 236 W ALEXANDER STREET CHICAGO IL 60616

PHONE: (312)720-8800 BILLY WANG68@HOTMAIL.COM LICENSE NO: 062.068227

EXPIRES: 11 / 30 /2021

INTERIOR

A A A

ISSUES	DATE
ISSUED FOR PERMIT	02/14/2021



ELECTRICAL PLAN & NOTES

SHEET NUMBER



A PLUMBING PLAN SCALE 3/8"=1'-0"


PLUMBING FIXTURES	NO.	LOAD IN SUP	PLY FIXTURES	UNITS
		COLD	НОТ	TOTAL
TOILET	1	3		3
LAVATORY	1	1	1	2
1 PREP SINK	1	3	3	4
ICE MAKER	1	1		1
MOP SINK	1	3	3	4
3-COMP SINK	1	3	3	4
HAND SINK	1	1	1	2
TOTAL				20

PLUMBING FIXTURES)
PLUMBING FIXTURES	QTY
WATER CLOSET	1
LAVATORY	1
HAND SINK	1
3-COMP SINK	1
MOP SINK	1
ICE MAKER	1
PREP SINK	1
50GL WATER HEATER	1
TOTAL	8

BING FIXTURES		GREASE TRAP CALCUL	JLATION		
NG FIXTURES CLOSET RY	QTY 1	3(16"X16"X12") COMP SINK 24"X24"X8" MOP SINK	VOL. (GAL.) 39.8 20		
NK SINK	1	F.D. TOTAL	6 66 GAL.		
K	1	THEREFORE, MIN. GREASE TR. LIQUID HOLDING CAPACITY	i Ap requirement: 66x60% or 50gp		
ER IK	1	THEREFORE , PICK 50GPM. LIQUID HOLDING CAPACITY AS PER			
ATER HEATER	8	PLUMBING CODE, 890.510			

INSTALL THERMAL EXPANSION TANK -

PLUMBING FIXTURES	S AND FITTIN	GS SCHEDULE
FIXTURE	MODEL	MODEL NO/ REMARKS
WATER CLOSET	KOHLER	ADA COMPLAINT,FLOOR MOUNTED
LAVATORY	KOHLER	ADA COMPLAINT, WALL MOUNTED
FAUCET	KOHLER	ADA COMPLAINT,ASME/ANSI 116/117 COMPLIANT,SET TO 110F MAX
TEMPERING VALVE	WATTS	1170-M2
TOILET PAPER DISPENSER	BOBRICK	B5288 ADA
GRAB BARS	BOBRICK	B66806 SERIES, 36" AND 42"
SOAP DISPENSER	BOBRICK	B82216 SURFACE MOUNTED
MIRROR	BOBRICK	B-165 (ADA COMPLIANT)
TRASH RECEPTACLE	BOBRICK	B-275 WALL MOUNTED
HAND DRYER	WORLD DRYER	WA126-2 PWHC WHITE AIRSPEED SURFAC MOUNTED MOUNT
		38" AFF.FOR ACCESSIBILITY

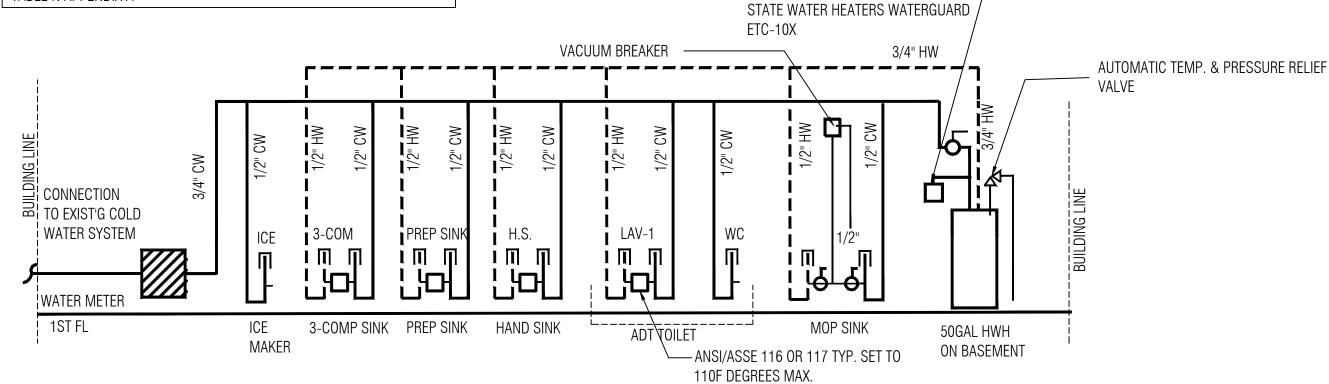



B WATER SUPPLY RISER DIAGRAM NOT TO SCALE


PLUMBING NOTES


- 1. PROVIDE ALL LABOR, MATERIALS, REQUIRED PERMITS, INSPECTION FEE NECESSARY FOR AND INCIDENTAL TO THE INSTALLATION OF COMPLETE PLUMBING SYSTEM INCLUDING ALL PIPES, FITTINGS , EQUIPMENTS AND NECESSARY APPURTENANCE.
- 2. ALL PLUMBING INSTALLATIONS SHALL MEET STATE OF ILLINOIS PLUMBING CODE REQUIREMENTS.
- 3. ALL ABOVE GROUND SUPPLY WATER PIPING SHALL BE COPPER TYPE "L". TYPE "K" COPPER FOR UNDERGROUND . ALL UNDERGROUND VACUUM LINES TO BE TYPE "K"
- 4. PROVIDE DOUBLE CHECK VALVES WITH ATMOSPHERIC VENTS OR REDUCED PRESSURE ZONED BACKFLOW PREVENTERS CAPABLE OF BEING SUBMERGED ON WATER INLETS WHERE YOU CANNOT INSTALL A VACUUM BREAKER AFTER THE LAST SHUT OFF VALVE OR SOLENOID SWITCH.
- 5. ALL PLUMBING VENT TERMINALS SHALL BE LOCATED NOT LESS THAN TWELVE FEET (12') HORIZONTALLY FROM ANY FRESH AIR INTAKE AT THE ROOF.
- 6. PROVIDE THERMOSTATIC MIXING VALVE TO EACH LAV. FAUCET AND AS INDICATED ON SUPPLY RISER DIAGRAM WITH WATER TEMPERATURE SETTING POINT OF 110° F - DEVICE TO COMPLY W/ ANSI/ASSE 1016 OR 1017.
- 7. TO PREVENT BACKFLOW AN ANSI 1013 COMPLIANT RPZ MUST BE INSTALLED FOR ALL SOAP ASPIRATORS.

systems with hot water storage shall have a properly sized thermal expansion tank located in the cold water supply as near to the water heater as possible and with no shut-off valve or other device between the heater and the expansion

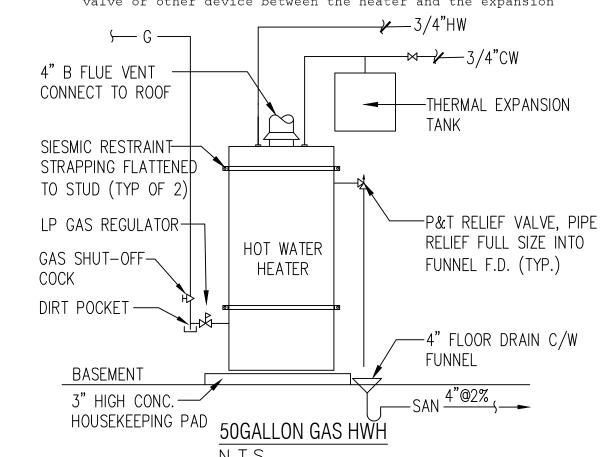

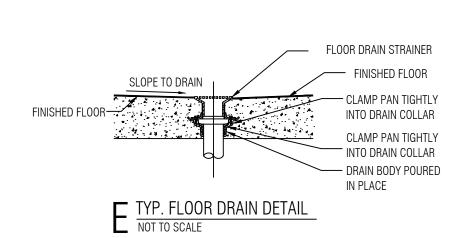

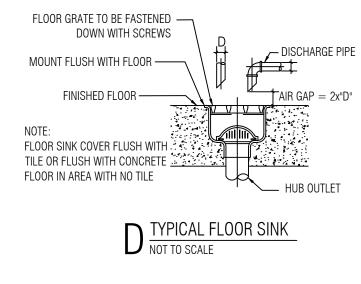

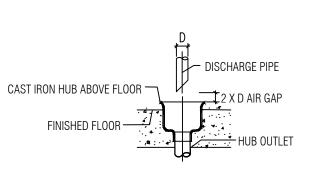

TYP. INDIRECT WASTE CONNECTION (OSD)

1 PLUMBING NOTE

11 GENERAL

- -1 OPENINGS IN WALLS, FLOORS, AND CEILINGS FOR PIPE PASSAGE TO BE CLOSED OFF AND PROTECTED BY METAL COLLARS
- SECURELY FASTENED TO THE STRUCTURE -2 PROTECTION OF ALL PIPIING FROM CORROSION, BREAKAGE
- STRESS AND STRAIN, FREEZING AND PHYSICAL DAMAGE
- -3 FLOOR DRAIN MIN 3" WATER SEAL; OPENING 2/3 OF PIPING;
- -4 WATER SERVICE MIN 60" BELOW GRADE
- -5 WATER HEATER SHUT OFF VALVE IN COLD LINE WITHIN 5'
- -6 DRAINAGE PIPING UNIFORM GRADE FOR HORIZONTAL PIPING
- -7 NOT SMALLER THAN 4" DIAMETER at 1/4" PER FOOT SLOPE
- -8 3"-8" SIZE AT MIN 1/8" PER FT SLOPE -9 BRANCH SHUT OFF VALVE TO BE 125 PSI BALL VALVE
- -10 PROVIDE DIELECTRIC FITTINGS AND SEPARATION BETWEEN DISSIMILAR METALS
- -11 24" AIR CHAMBER TO EACH MAIN WATER RISER; 12" TO EACH FIXTURE
- -12 AUTOMATIC MIXING VALVE TO PUBLIC LAVATORIES
- PER ANSI/ASSE 1016 OR 1017
- 21 SEWER DEPTH BELOW FROST LINE
- 22 ADEQUATE STRUCTURAL SUPPORT AND ANCHORAGE

HANGER SPA			
HORIZONTAL	VERTI	CAL	
4'	10'		
5'	15'		
6 '	10'		
	HORIZONTAL 4' 5'	4' 10' 5' 15'	HORIZONTAL VERTICAL 4' 10' 5' 15'

- 23 UNDERGROUND INSTALLATION PREVENT FROM WAETR SEEPAGE & ACCUMULATION
- 24 CONDENSATION DRAINAGE FOR COOLING COILS

30	WATER SU	JPPLY PIP	ING							
			SERVICE	DISTR	IBUTION					
	MATERIAI		PIPE	PIPE						
	COPPER		ASTM B42-1	988						
	ABOVE GF	RADE TYPE	L HARD COP	PER W	ITH LEAD	FREE	SOLDERI	NG J	OINTS	
	TYPE K E	OR UNDER	GROUND WITH	WROU	GHT COPE	PER FI	TTINGS			
	WATER PI	PING TO	BE INSULATE	!D						

WITH 1/2" THICK 3 LBS DENSITY FIBERGLASS


40 SANITARY PIPING

ALL SANITARY AND VENT PIPING TO BE SERVICE WEIGHT CAST IRON

PIPE WITH CAULED JOINTS ABOVEGROUND UNDERGROUND PIPE FITTINGS MATERIAL DRAINAGE & VENT SERVICE WEIGHT ASTM A 74; ASTM A 74; ASME B 16; 16.12 CASR IRON CISPI 301 CISPI 301 ASTM A 74; 888 **ASTM A 888 ASTM A 888** CISPI 301

50 CLEAN OUT MIN 4" SIZE

- -1 HORIZONTAL DRAINS AT 100' APART
- -2 BUILDING SEWER AT 100' INTERVAL -3 AT CHANGE OF DIRECTION
- -4 BASE OF STACK
- -5 JUNCTION OF DRAIN AND SEWER
- 51 ALL BRANCH PIPING SHUT-OFF VALVES TO BE 125 PSI BALL VALVE 52 ALL GAS PIPING TO BE SCHEDULE 40 BLACK STEEL PIPE WITH
- 125 PSI SCREW FITTING; FLEXIBLE PIPING MUST BE UL LISTED
- 53 PROVIDE 24" AIR CHAMBER TO EACH MAIN WATER RISER;
- 12" AIR CHAMBER TO EACH FIXTURE

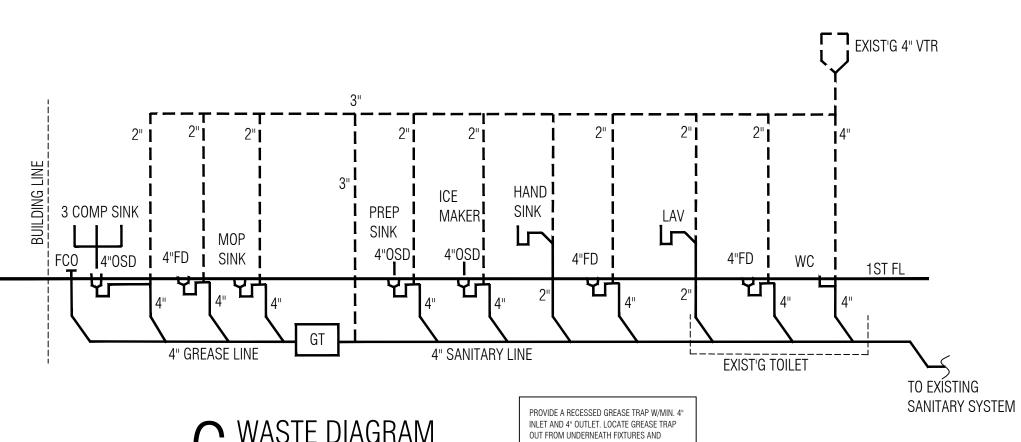

WASTE DIAGRAM
NOT TO SCALE

ALL WASTELINES TO BE A MINIMUM OF 4" IN DIAMETER PIPING.

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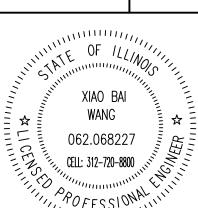
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