GENERAL PROJECT NOTES

SUMMARY OF WORK

INTERIOR REMODELING OF THE EXISTING 1ST FLOOR 2205SF SPACE TO A NEW RESTAURANT, PROVIDE ALL NECESSARY ARCHITECTURAL, ELECTRICAL, , MECHANICAL & PLUMBING WORK AS NOTED.

GENERAL INSTRUCTIONS

THESE DRAWINGS ARE SCOPE DOCUMENTS INDICATING THE GENERAL PROJECT DESIGN CONCEPT, DIMENSIONS OF THE PROJECT, MAJOR ARCHITECTURAL ELEMENTS. AND BASIC ORGANIZATION OF MECHANICAL, ELECTRICAL AND PLUMBING SYSTEMS. AS SCOPE DOCUMENTS, THESE DRAWINGS DO NOT NECESSARILY DESCRIBE OR INDICATE ALL MATERIALS OR WORK REQUIRED FOR FULL PERFORMANCE AND COMPLETION OF THE PROJECT. ON THE BASIS OF THE GENERAL SCOPE INDICATED OR DESCRIBED, THE CONTRACTOR(S) SHALL FURNISH ALL ITEMS REQUIRED FOR PROPER EXECUTION AND COMPLETION OF THE PROPOSED PROJECT. THE ARCHITECT IS NOT RESPONSIBLE FOR THE FAILURE OF THE CONTRACTOR(S) TO EXECUTE NECESSARY WORK OR TO SUPPLY REQUIRED MATERIALS FOR PROPER COMPLETION OF THIS PROJECT. FURTHER MORE THE ARCHITECT MAKES NO WARRANTY EXPRESSED OR IMPLIED ON THESE DOCUMENTS.

DUE TO THE NATURE OF THIS WORK THE ARCHITECT DOES NOT WARRANT THE EXISTING CONDITIONS AS DEPICTED IN THESE DRAWINGS AS BUILT CONDITIONS. THE MEASUREMENTS ON THESE DRAWINGS ARE REASONABLY ACCURATE FOR THE PURPOSE OF "FIGURING." HOWEVER, IN THE EXECUTION OF WORK ON THE JOB, DO NOT SCALE DRAWINGS. EACH CONTRACTOR IS REQUIRED TO VERIFY ALL DIMENSIONS WITH THE ACTUAL CONDITIONS AND TO REPORT ANY DISCREPANCIES TO THE ARCHITECT, OWNER, OR THE OWNER'S REPRESENTATIVE.

CONTRACTOR SHALL OBTAIN AND PAY FOR ANY PERMITS AND FEES REQUIRED TO PERFORM THE WORK, UNLESS DIRECTED OTHERWISE BY OWNER.

EACH CONTRACTOR SHALL BE RESPONSIBLE FOR STORAGE AND SAFETY OF HIS OWN MATERIALS AND WORK, AND FOR PROPERLY REMOVING HIS DEBRIS FROM THE JOB SITE. GENERAL CONTRACTOR (GC) SHALL PROVIDE FOR ALL SITE DEMOLITION AND DEBRIS REMOVAL REQUIRED TO PERFORM NEW CONSTRUCTION WHILE ADEQUATELY MAINTAINING THE PREMISES AND ADJACENT PREMISES TO INSURE NORMAL OCCUPANCY AND SECURITY. THE GC SHALL COORDINATE PROPER TRANSPORTATION AND STORAGE OF BUILDING MATERIALS ON THE SITE TO AVOID OVERLOADING OF EXISTING FLOOR.

CONTRACTORS INSTALLING PIPES, DUCTS AND CONDUIT WILL BE REQUIRED TO DO ALL CUTTING AND PATCHING IN CONNECTION WITH THEIR WORK, INCLUDING EXCAVATION AND DIGGING. THE OWNER WILL ASSUME NO RESPONSIBILITY FOR THE COST OF CHANGES OR EXTRA WORK MADE NECESSARY BY THE FAILURE OF TRADES TO COORDINATE THEIR WORK DURING CONSTRUCTION.

WHERE APPLICABLE THE GC SHALL CONSTRUCT PHYSICAL BARRIERS AROUND AREAS UNDER CONSTRUCTION AS REQUIRED TO ENSURE GENERAL PUBLIC AND PERSONAL SAFETY.

THE GC SHALL SUPERVISE AND DIRECT THE WORK, HE SHALL BE SOLELY RESPONSIBLE FOR ALL CONSTRUCTION MEANS, METHODS, TECHNIQUES, SEQUENCES AND PROCEDURES. THE GC SHALL BE RESPONSIBLE FOR COORDINATING ALL PORTIONS OF THE WORK UNDER HIS CONTRACT. ALL WORK SHALL BE COMPLETED USING PRACTICES ACCEPTED AND ENDORSED BY THE CORRESPONDING TRADE INDUSTRIES.

THE TERM "PROVIDE" SHALL MEAN TO FURNISH AND INSTALL.

THE CONTRACT AND SUBCONTRACT AMOUNTS SHALL PROVIDE COMPLETE WORKING MECHANICAL, ELECTRICAL AND PLUMBING SYSTEMS COMMENSURATE WITH THE REQUIREMENTS OF THE CONTRACT DOCUMENTS AND THE APPLICABLE CODES.

WHEN WALLS ARE TO BE "ALIGNED", THE ALIGNMENT OF SUCH WALLS IS TO THE OUTSIDE FINISHED SURFACE, SUCH AS DRYWALL SURFACE.

ALL DIMENSIONS SHOWN ARE TO FINISH FACE OF WALL UNLESS NOTED OTHERWISE. DIMENSIONS AND NOTES FOR A GIVEN CONDITION ARE TYPICAL FOR ALL SIMILAR CONDITIONS UNLESS NOTED OTHERWISE.

WHERE NEW WORK ADJOINS EXISTING, ALL SUCH NEW WORK SHALL BE PROPERLY INTERGRATED WITH THE EXISTING TO ENSURE UNIFORM APPEARANCE. ANY REPAIR WORK REQUIRED TO EXISTING WORK SHOULD BE TAKEN CARE OF BY THE CONTRACTOR - PROVIDING ALL NECESSARY CUTTING, FITTING AND PATCHING AND SHALL FURNISH ALL NECESSARY LABOR AND MATERIALS FOR THIS WORK. ALL WORK REQUIRING SPECIAL DETAILING, AND NOT DETAILED ON THE DRAWINGS SHOULD BE BROUGHT TO THE ATTENTION OF THE ARCHITECT / OWNER.

THE GENERAL CONTRACTOR SHALL COORDINATE ALL TRADES TO AVOID INTERFERENCE, TO PRESERVE MAXIMUM HEADROOM, AND AVOID OMISSIONS.

THE ARCHITECT HAS NO CONTRACTUAL DUTY TO CONTROL MEANS AND METHODS OF THE WORK NOR TO PROVIDE JOB SITE SUPERVISION. ENSURE SAFETY OR CONSTRUCTION MANAGEMENT AND DOES NOT VOLUNTARILY ASSUME ANY SUCH RESPONSIBILITIES.

ADA NOTES


THE INTENT OF THESE DOCUMENTS IS TO COMPLY WITH THE AMERICANS WITH DISABILITIES ACT OF 1990 (ADA) WITH AMENDMENTS AND THE ILLING'S BUILDING CODE (IBC), CHAPTER II, ACCESSIBILITY, WHEREVER POSSIBLE. THE CONTRACTOR SHALL INCORPORATE INTO THE WORK, BUT IS NOT LIMITED TO, THE FOLLOWING ITEMS:


- HARDWARE: ALL NEW DOOR HANDLES SHALL BE LEVER-OPERATED AND BE MOUNTED AT 36" ABOVE FINISHED FLOOR.
- DOORS WITH CLOSERS SHALL HAVE A SWEEP PERIOD SO THAT FROM AN OPEN POSITION OF 70 DEGREES, THE DOOR WILL TAKE AT LEAST 3 SECONDS TO MOVE TO A POINT 3" FROM THE LATCH, MEASURED TO THE LEADING EDGE OF THE
- DOOR OPENING FORCE SHALL BE ADAAG 4.13.11: A. FIRE DOORS: MINIMUN ALLOWABLE BY CODE B. EXTERIOR HINGED DOORS: 8.5 LBS. C. INTERIOR HINGED DOORS: 5.0 LBS.
- THRESHOLDS AT DOORWAYS SHALL NOT EXCEED 1/2" IN HEIGHT. RAISED THRESHOLDS AND FLOOR LEVEL CHANGES AT ACCESSIBLE DOORWAYS SHALL BE BEVELED WITH A SLOPE NOT GREATER THAN 1:2. ADAAG 4.13.8.
- ANY SIGNAGE INSTALLED BY THE CONTRACTOR SHALL COMPLY WITH ADAGS 4.30.
- ALL CONTROLS AND OPERATING MECHANISMS REQUIRED TO BE ACCESSIBLE ARE TO BE INSTALLED AT A MAXIMUM HEIGHT OF 48" AND A MINIMUM HEIGHT OF 15" ABOVE FINISHED FLOOR PER ADAAG 4.2.5, 4.2.6. AND 4.27.3.

AC - ACGT00048 - SALES/ SERVICE COUNTER MUST CONSIST OF ADEQUATE CLEAR FLOOR SPACE (PER SEC. 305) FOR PARALLEL AND FORWARD APPROACH AND FULLY COMPLY TO ICC/ ANSI SEC. 904

NOTE: A 36"L MIN. X 36"H MAX. COUNTER MAY CONSIST OF A PARRALLEL APPROACH.

NOTE: A 30"L MIN. X 36"H MAX. COUNTER MUST CONSIST OF A FORWARD APPROACH.

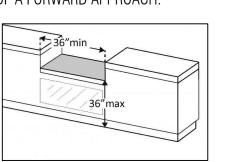

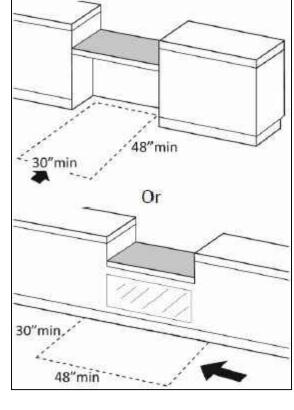

ACCESSIBILITY REQUIREMENTS

ACCESSIBILE SIGNAGE

TOILET FLUSH VALVE ON OPEN (WIDE) SIDE

___ NOT TO SCALE


IAC 400.310(N)(4)


ACCESSIBILE MOUNTING HEIGHTS

LAVATORY

B TYPICAL ACCESSIBILITY REQUIREMENTS
NOT TO SCALE


TOILET ROOMS REQUIRED TO BE ACCESSIBLE SHALL CONFORM TO ALL ACCESSIBILITY REQUIREMENTS OF THE AMERICANS WITH DISABILITIES ACT WHICH INCLUDES, BUT IS NOT LIMITED TO THE FOLLOWING:

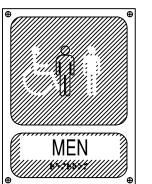

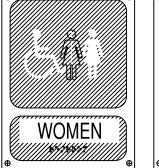




-TOILET PAPER

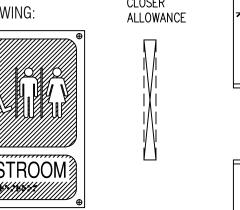

NOT TO SCALE

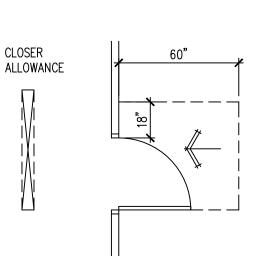


DOOR MANEUVERING CLEARANCE

—ELEC OUTLET


SOAP -DISPENSER

5'-0" TURNING RADIUS

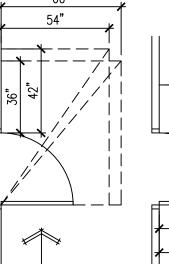


- 18"X36" MIRROR


LEVER STYLE FAUCET AT LAV.

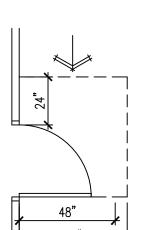

ACCESSIBLE -

SIGNAGE

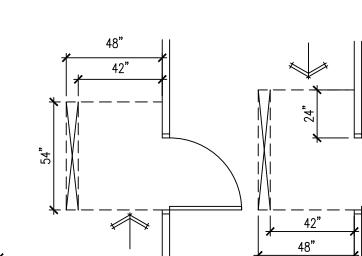

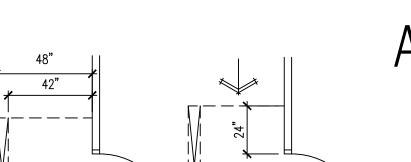

Verizon Authorized

Cell phone store

Retailer, The Digital Store

GARBAGE DUMPSTER & GREASE CONTAINER AT THE BACK OF BUILDING

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44"

I HEREBY CERTIFY THAT THESE DRAWINGS ARE PREEPARED BY ME OR UNDER MY SUPERVISION AND TO THE BEST OF MY KNOWLEDGE CONFORM WITH APPLICABLE CODES.

CODE DATA

ALL CONSTRUCTION SHALL BE IN ACCORDANCE WITH ALL APPLICABLE FEDERAL, STATE AND MUNICIPAL LAWS, ORDINANCES, STANDARDS AND REGULATORY AGENCIES INCLUDING BUT NOT LIMITED TO THE REQUIREMENTS (INCLUDING LOCAL AMENDMENTS) OF

955 W Jackson St,

Morton, IL 61550

2015 INTERNATIONAL BUILDING CODE 2015 INTERNATIONAL FIRE CODE 2015 INTERNATIONAL FUEL GAS CODE 2015 INTERNATIONAL MECHANICAL CODE 2018 INTERNATIONAL ENERGY CONSERVATION CODE 2014 NATIONAL ELECTRICAL CODE 2014 ILLINOIS STATE PLUMBING CODE 2018 ILLINOIS ACCESSIBILITY CODE

LOCAL VILLAGE OF MORTON CODE AMENDMENTS

INDEX OF DRAWINGS

PROJECT NOTES & SITE PLAN

FLOOR PLANS & NOTES SCHEDULES & NOTES

MECHANICAL PLANS & NOTES

ELECTRICAL PLANS & NOTES PLUMBING PLANS & NOTES

PROJECT DATA

A-2

2205SF

III-B (EXIST'G)

75 FT MAXIMUM

40 OCCUPANTS

8 OCCUPANTS

52 OCCUPANTS

1 STORY

YES, FULLY SPRINKLERED (EXIST'G)

ACTUAL 2

(680/200) = 4 OCCUPANTS

USE GROUP CLASSIFICATION

EXIT ACCESS TRAVEL DISTANCE

AUTOMATIC SPRINKLERS

DINING AREA (FIXED SEATS)

TOTAL OCCUPANT LOADS

REQUIRED NUMBER OF EXITS:

MINIMUM CORRIDOR WIDTH

CONSTRUCTION TYPE

AREA TOTAL

BAR AREA

KITCHEN AREA


MAXIMUM HEIGHT

LIC EXPIRES NOV 30, 2022

SHEET NUMBER

PROJECT NOTES,

SITE PLAN

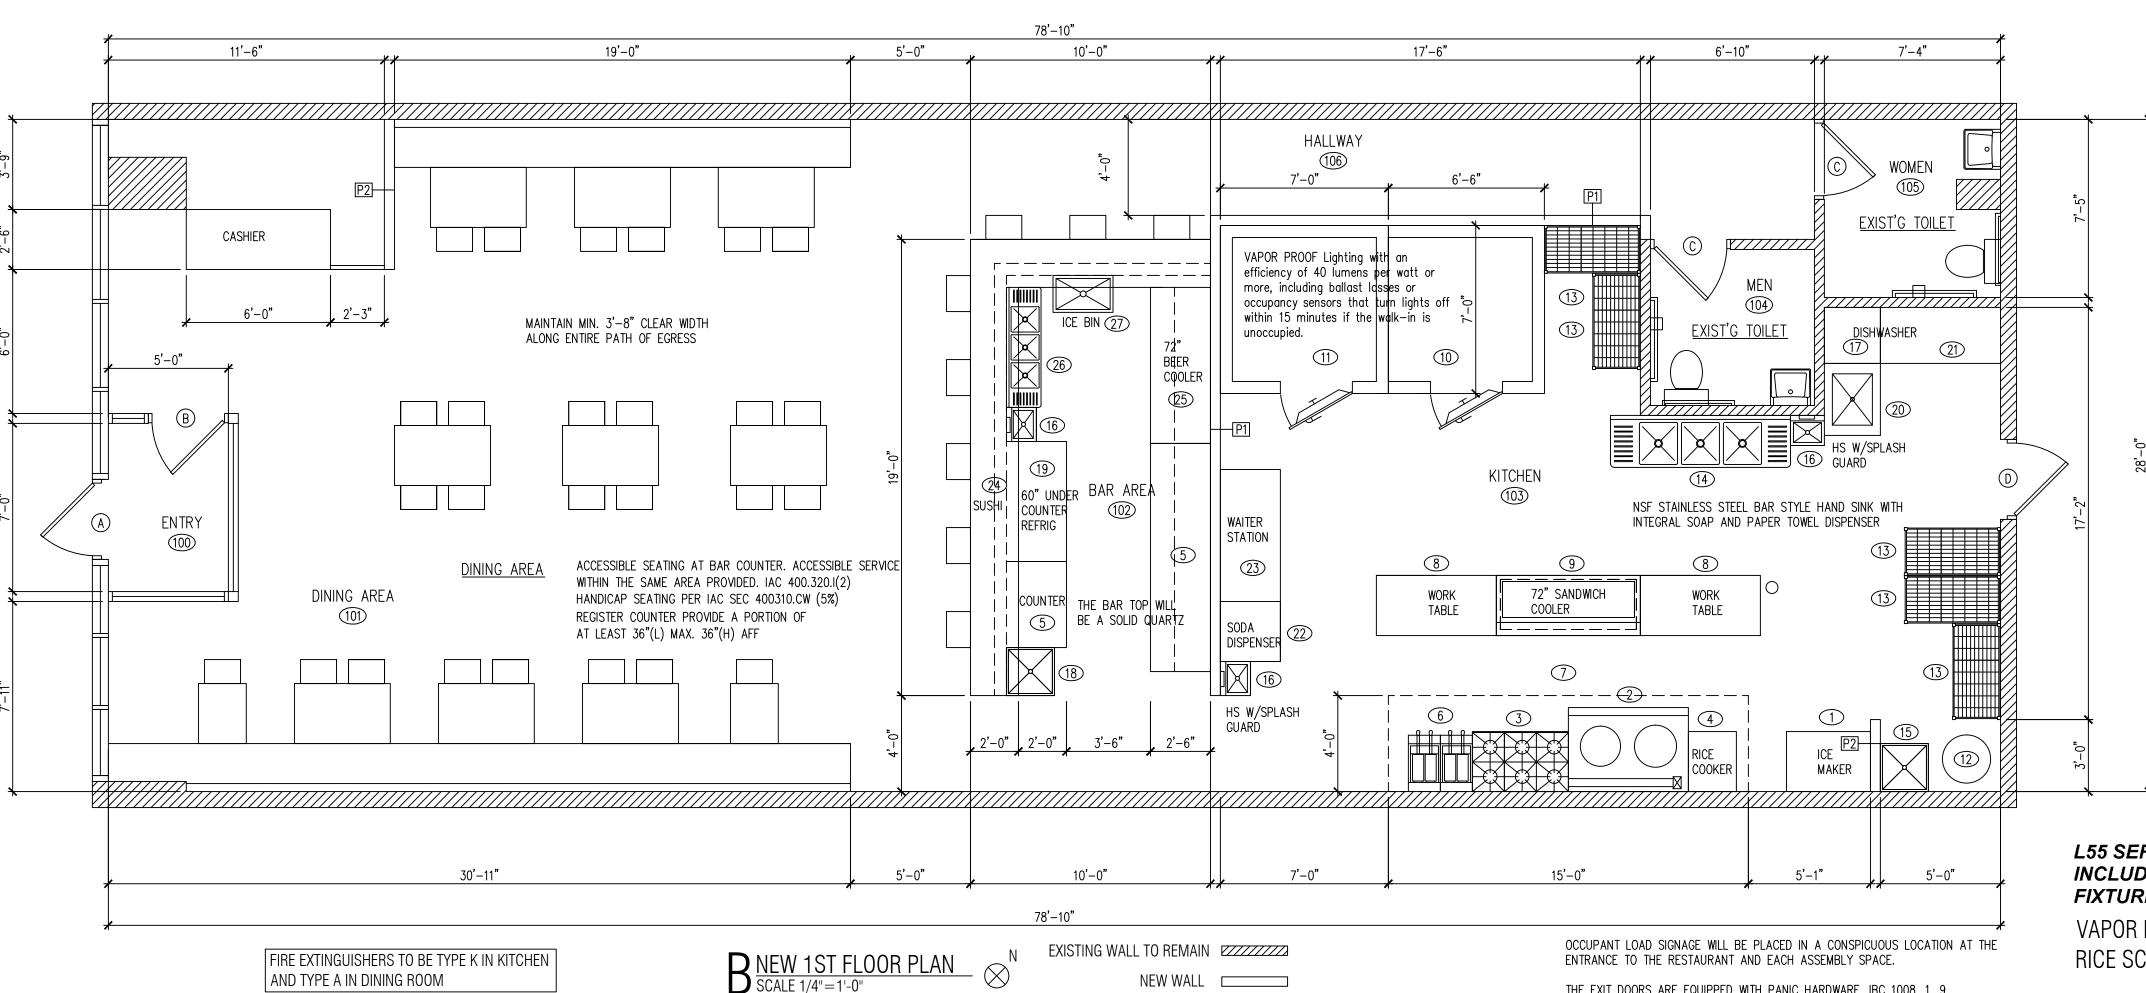

EXISTING WOMEN EXISTING MEN EXISTING SPACE


 \bigwedge 1ST FLOOR DEMO PLAN \otimes^N

L55 SERIES E26 CANOPY LIGHT FIXTURE - HIGH TEMP ASSEMBLY, INCLUDES CLEAR THEMRAL AND SHOCK RESISTANT GLOBE (L55 FIXTURED)

VAPOR PROOF LIGHT FIXTURE IN THE WALK IN COOLER AND FREEZER. RICE SCOOPS SHALL BE STORED IN THE STAINLESS STEEL CONTAINER.

THE EXIT DOORS ARE EQUIPPED WITH PANIC HARDWARE. IBC 1008. 1. 9

EMERGENCY AND GENERAL EGRESS DISCHARGE LIGHTING. IBC 1006.1 ON SHEET E1

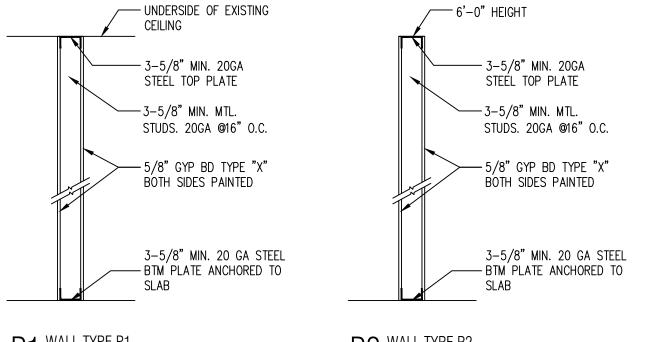

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RIOR

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FLOOR PLANS & NOTES

SHEET NUMBER



					EQUIPMENT SCH	IEDULE	
NO	QTY	DESCRIPTION	GAS	ELEC	TRIC	PLUMBING	REMARKS
1	1	ICE MAKER	-	220V	13.6A	3/8" CW	NSF,AIR COOLED CONDENSING UNIT
2	1	2 BURNER CHINESE WOK	3/4"	-	I=	1/2"CW, 4" INDIRECT DRAIN	NSF, 220000 BTU
3	1	6 BURNER	3/4"	-	-	_	NSF, 90000 BTU
4	1	GAS RICE COOKER	1/2"	-	=	-	NSF, 40000 BTU
5	2	COUNTER W/CABINETS	E .	=	-	-	NSF
6	2	DEEP FRYER W/CASTERS	3/4"	_	-	_	NSF, 110000 BTU
7	1	15'-0"X4'-0" EXHAUST HOOD, TYPE I	E	-	-	-	U.L. W/ANSUL FIRE SUPPRESSION SYSTEM
8	2	WORK TABLE	-	_	-	_	NSF,W/ 6" STAINLESS STEEL LEGS NSF APPROVED
9	1	REFRIGERATED PREP TABLE	=	120V	4A	_	NSF,W/ CASTERS
10	1	7'-0"X6'-6" WALK-IN COOLER	-	220V	9A	_	NSF
11	1	7'-0"X7'-0" WALK-IN FREEZER	E	220V	9A	_	NSF
12	1	HOT WATER HEATER	1"	120V	-	3/4" CW & 3/4" HW	NSF, 75GALLONS
13	5	SHELVING	Ε.	=	-	-	NSF APPROVED STAINLESS STEEL SHELVING
14	1	3 COMPARTMENT SINK	-	-	-	1/2" CW,1/2" HW,4" INDIRECT DRAIN	NSF,W/ ECOLAB PATHWAY TO PREVENT BACKFLOW
15	1	MOP SINK/A FLOOR BASIN UNIT	=	=		1/2"CW,1/2" HW, 4" DRAIN	NSF, W/ MOP HOOKS, SEAL EDGES
16	3	HAND SINK	-	-	I=	1/2" CW,1/2" HW, 2" DRAIN	NSF, WALL MOUNTED - SEALED
17	1	DISHWASHER	-	220V	1.5KW	1/2" HW, 4" INDIRECT DRAIN	NSF
18	1	PREP SINK	_	-	I=	1/2"CW,1/2" HW, 4" INDIRECT DRAIN	NSF
19	1	60" UNDER COUNTER REFRIG.	-	120V	4A	-	NSF
20	1	3' DISHTABLE (SOILED)	-	-	-	1/2" HW, 4" INDIRECT DRAIN	NSF,W/ 6" STAINLESS STEEL LEGS NSF APPROVED
21	1	3' DISHTABLE (CLEAN)	-	-	-	-	NSF,W/ 6" STAINLESS STEEL LEGS NSF APPROVED
22	1	30"X30" SODA DISPENSER	_	120V		1/2"CW, 4" INDIRECT DRAIN	NSF
23	1	WAITER STATION	_	-	-	ı-	NSF
24	1	SUSHI COUNTER	_	-	-	-	NSF
25	1	72" BEER COOLER	-	120V	4A	-	NSF
26	1	3 COMPARTMENT BAR SINK	_	-	I=	1/2" CW,1/2" HW,4" INDIRECT DRAIN	NSF,W/ ECOLAB PATHWAY TO PREVENT BACKFLOW
27	1	ICE BIN	-	-	-	4" INDIRECT DRAIN	NSF
ALL	EQUIPN	MENTS WILL BE NSF APPROVED CLEAN,OPE	RABLE AND SU	JBJECT TO	THE FINAL APPROVAL BY	THE HEALTH	

	ROOM FINISH SCHEDULE									
NO	ROOM	WALLS	BASE	FLOOR	CEILING					
100	ENTRY	GYP. BD. PAINTED	QT COVE BASE	FLOOR TILE	EXIST'G 2'X4' CLG.					
101	DINING AREA	GYP. BD. PAINTED	QT COVE BASE	FLOOR TILE	EXIST'G 2'X4' CLG.					
102	BAR AREA	CERAMIC TILE	QT COVE BASE	QUARRY TILE	2'X4' VINYL TILE CLG.					
103	KITCHEN	STAINLESS STEEL	QT COVE BASE	QUARRY TILE	2'X4' VINYL TILE CLG.					
104	MEN'S	EXIST'G	CERAMIC TILE	EXIST'G FLOOR TILE	EXIST'G CLG.					
105	WOMEN'S	EXIST'G	CERAMIC TILE	EXIST'G FLOOR TILE	EXIST'G CLG.					
106	HALLWAY	GYP. BD. PAINTED	QT COVE BASE	FLOOR TILE	EXIST'G 2'X4' CLG.					

DEPARTMENT

	DOOR SCHEDULE											
TAG	DESCRIPTION	FRAME CONSTRUCTION	HI CONTRACTOR OF THE CONTRACTO	DOOR FINISH	FRAME FINISH LABEL	HARDWARE SET	COMMENTS					
A	STORE FRONT GLASS DOOR	ALUMINUM	W X H 3'-0" x 7'-0"	TEMPERED GLASS	ALUMINUM -	2	EXIST'G FRONT EXIT DOOR					
В	TEMPERED GLASS DOOR	ALUMINUM	3'-0" x 7'-0"	TEMPERED GLASS	ALUMINUM -	2	NEW					
С	HOLLOW METAL DOOR	HOLLOW METAL	3'-0" x 6'-8"	PAINT	PAINT -	1	EXIST'G					
D	HOLLOW METAL DOOR	HOLLOW METAL	3'-6" x 6'-8"	PAINT	PAINT -	2	EXIST'G					
	* ALL EXIT DOORS MUST	OPEN WITHOUT THE US	E OF A KEY OR S	SPECIAL KNOWLED	GE FROM THE SID	WHICH EGRES	S IS MADE					
	* LEVERED HANDLE HARD	OWARE AS REQUIRED BY	'ILLINOIS ACCES	SSIBILITY CODE								
	* PROVIDE DOOR CLOSE	RS ALONG ALL ACCESSI	BLE ROUTES									

HARDWARE SCHEDULE						
TAG	DESCRIPTION					
1	3 HINGES, W/LEVERED PRIVACY LOCKSET, KICKPLATE AND DOOR CLOSER					
2	PADDLE LATCH EXIT DEVICE AND DOOR CLOSER, PANIC HARDWARE					
3	PRIVACY LOCKET					

COOKLINE EQUIPMENT AND REACH-IN REFRIGERATION AND FREEZER UNITS TO BE INSTALLED ON CASTERS. NSF STAINLESS STEEL SHELF OVER 3-COMPTMENT SINK. ICE MAKER A MIN. 8" FROM ALL WALLS. HEAVY-DUTY MOP RACKS LOCATED OVER MOP SINK. HEAVY-DUTY BROOM RACKS IN JANITORIAL AREA. METAL GARBAGE CANS WITH LIDS FOR RESTROOMS. SANITARY BOX IN WOMEN'S RESTROOMS. METAL GARBAGE CANS WITH LIDS FOR DIAPER CHANGING STATION.

ALL NSF APPROVED HAND SINKS TO BE WITH BLADE HANDLED FAUCETS.

WAITRESS, BEVERAGE STATION & BAR COUNTER TOP -STAINLESS STEEL.

ALL CABINET SHELVES -STAINLESS STEEL.


ALL CABINET BASE - 6" STAINLESS STEEL LEGS (NO KICK BASE)

LAVATORY COUNTERTOP TO BE SOLID SURFACE (NO PLASTIC LAMINATE OR CABINETRY)

ANY PAINTED FINISHES TO BE SEMI-GLOSS OR GLOSS (NO FLAT, NO EGG SHELL, NO TEXTURE),

PROVIDE FRP ON WALL AND UNDERSIDE OF BAR.

STAINLESS STEEL WALL FINISH FOR BEHIND AND ADJACENT TO COOK LINE

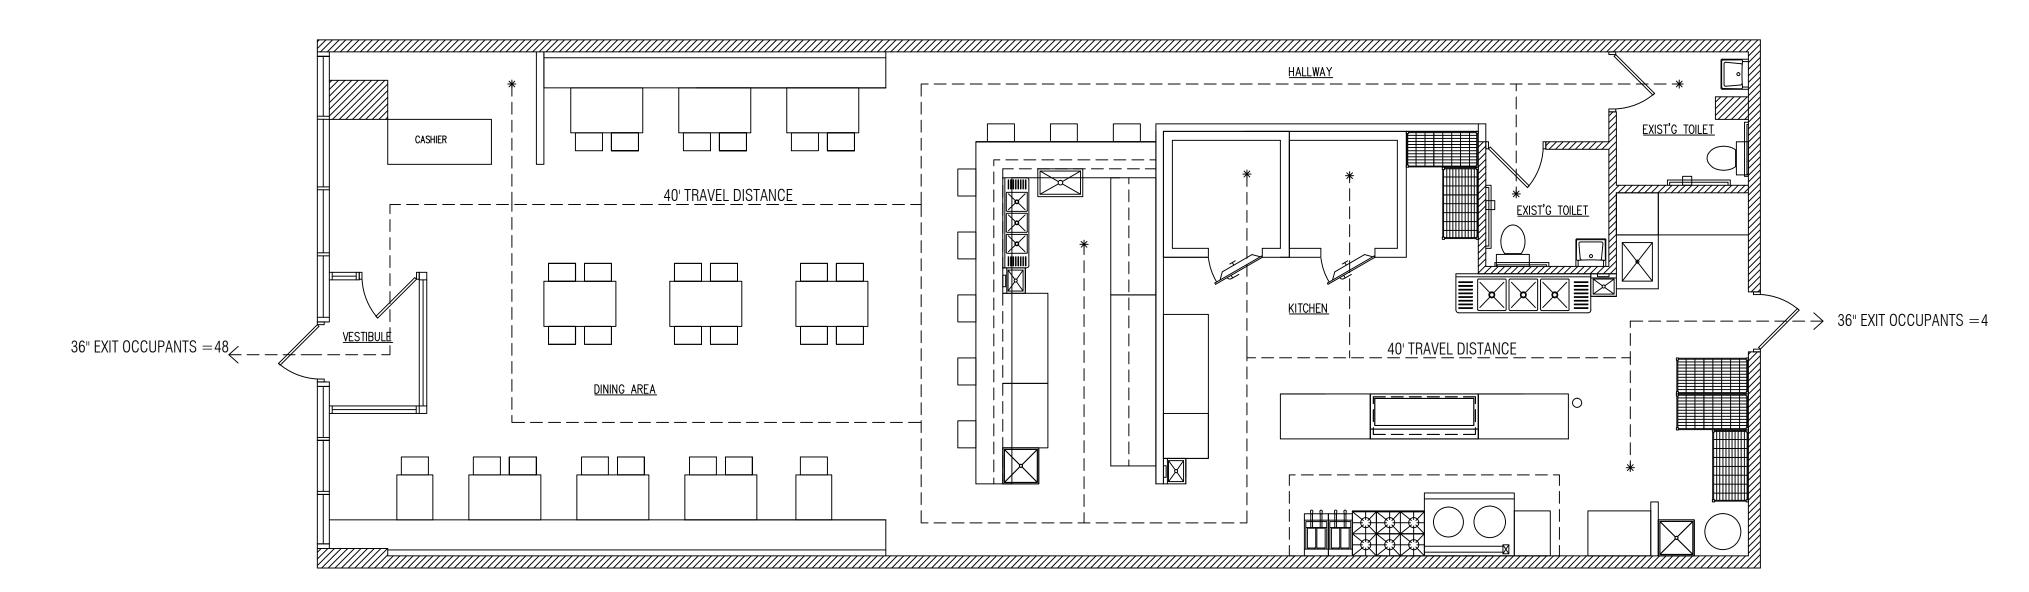

OCCUPANCY & EXITING DIAGRAM

SCALE 3/16"=1'-0"

KITCHEN EQUIPMENT NOTES

CONTRACTOR SHALL INSTALL AND CONNECT ALL EQUIPMENT AS PER EQUIPMENT SUPPLIER'S SPECIFICATIONS. ALL LOCATIONS TO BE VERIFIED WITH OWNER PRIOR TO INSTALLATION.

PLUMBING CONTRACTOR SHALL PROVIDE ALL ROUGH-INS. INSULATE ALL COLD/HOT WATER PIPES AS REQUIRED. MAINTAIN MIN 36" IN FRONT OF ALL COOKING EQUIPMENT.

ELECTRICAL CONTRACTOR SHALL PROVIDE ALL ELECTRICAL OUTLETS FOR EQUIPMENT. VERIFY ALL ELECTRICAL REQUIREMENTS WITH EQUIPMENT SUPPLIER. VERIFY ALL GAS AND WATER REQUIREMENTS WITH EQUIPMENT SUPPLIER.

ALL PERMANENT EQUIPMENT MUST BE LOCATED SO THAT AREAS BEHIND, UNDERNEATH, AND ON THE SIDES OF THE EQUIPMENT CAN BE EASILY CLEANED.

TWO DRAIN BOARDS ARE REQUIRED AT ALL THREE-COMPARTMENT SINKS ALONG WITH AN APPROPRIATELY SIZED FAUCET, LOCKABLE DRAIN PLUGS, AND AN INDIRECT CONNECTION TO THE SEWER.

DRY STORAGE

DRY STORAGE: 25% OF 600SF (KITCHEN AREA.)=150SF REQ'D ACTUAL DRY STORAGE 160SF PROVIDED.
5 SHELVINGS X 4X4X2 = 160SF

LIQUOR STORAGE: 35% OF 190SF (BAR AREA.) = 66SF REQ'D ACTUAL DRY STORAGE 75SF PROVIDED.

ALL FOOD AND FOOD RELATED ITEMS MUST BE STORED OFF THE FLOOR ON DURABLE WASHABLE SHELVES. THE STORAGE AREA MUST BE APPROPRIATELY SIZED BASED ON THE NUMBER OF MEALS SERVED DAILY AND THE NUMBER OF DELIVERIES WEEKLY.

ALL FOOD EQUIPMENT TO BE ON CASTERS, 6" LEGS, OR SEALED TO THE FLOOR FOR EASY CLEANING.

NO RAW WOOD SURFACES PERMITTED ANYWHERE. UNDERSIDES OF COUNTERTOPS, INSIDE OF CABINETRY, AND WATER HEATER PLATFORMS MUST BE SEALED.

- Dial stem thermometers (ranging from 0° to 220°F) are required in all preparation areas.
- Chemical test kits (specific to the sanitizer) are required for the appropriate sanitizer.
- pH meter and log for acidifying rice.
- All cooling/freezing units must have accurate thermometers.
- Covered waste cans are required in all restrooms.
- Toilets, urinals, hand sinks, 3 compartment sinks, mop sink, prep sinks, and permanent counters/cabinets must be sealed to floors and walls with a silicone caulk seal.
- Anti-siphon devices are required on all toilet tanks, urinals, and faucets with hose connections.
- Soap and paper towels are required at all hand sinks.
- Provide hair restraints and disposable gloves for all food handlers.

If sinks are provided with spring-loaded faucets, the faucets must remain running for a minimum of 15 seconds

Doors leading to the outside and restroom doors are required to be self-closing and tight-fitting. Please confirm that the doors leading to the outside are equipped with a self-closer and weather strips to eliminate any air gaps.

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LICENSE NO: 001-022013 EXPIRES: 11/30/2022

INTERIOR REMODELING

WEI TAN 001-022013

SSUED FOR PERMIT

SCHEDULES & NOTES

SHEET NUMBER



ELECTRICAL NOTES

- 1 The contractor shall visit the site and be familiar with the job condition prior to submitting the bid.
- 2 The contractor shall pay for all the taxes and fees and give local authorities all notices relating to his work.
- 3 Workmanship shall be done in a first class manner.
- 4 All materials used for this job shall be new and the best of their kind. 5 All work shall be done in accordance with all state and local codes.
- 6 The contractor shall guarantee all work and material for one year after completion against all defects of material, equipments and workmanship.
- 7 The contractor shall test system prior to operation. 8 Receptacles shall be grounding type.
- 9 Switches, receptacles, telephone outlets, etc. shall not be installed back to back. All receptacles, telephone and TV outlets shall be installed 1'-0" A.F.F. unless noted otherwise. Switches shall be 54" A.F.F.
- 10 Conduit runs shown on the drawings are diagrammatic. Actual field conditions should be followed.
- 11 Light fixtures installed shall be approved by the owner.
- 12 The contractor shall provide all materials, conduit, wiring, junction boxe etc. as required to complete and operate all systems.

WIRING NOTES

- 1. MINIMUM WIRE SIZES SHALL BE AS FOLLOWS:
 A. 15-AMP CIRCUITS #14 AWG.
 B. 20 AMP CIRCUITS #12 AWG.
- LARGER CIRCUITS AS NOTED. FEEDER RUNS ORIGINATING 75 FT. OR MORE FROM BRANCH CIRCUIT PANEL ONE WIRE SIZE LARGER THAN THAT LISTED.
- 2. WIRE ALL OUTLETS IN THE BUILDING AND LEAVE THEM READY FOR USE.
- 3. ALL APPLIANCE CONVENIENCE OUTLETS AND REFRIGERATOR OUTLETS SHALL BE WIRED TO THE 20 AMP APPLIANCE CIRCUIT WITH #12 WIRE.
- 4. ALL CONVENIENCE OUTLETS ABOVE THE COUNTERTOP SHALL BE INSTALLED WITH LONG DIMENSION OF THE PLATES HORIZONTAL.
- 5. ALL WIRING WITHIN BUILDING SHALL CONNECTED TO PANEL FOR THAT BUILDING.
- 6. THE TOP OF LOAD CENTER PANELS IN CLOSETS TO BE MAXIMUM OF 54 INCHE ABOVE FLOOR. 7. ALL WALL PLATES FOR ELECTRICAL WIRING SHALL BE PLUMB AND LEVEL

	EMEF	RGENCY LIGHT	FIXTURE SO	CHEDULE	
- 1					
I	TVDE	MANUICACTUDED	MODEL	LAMD	DECODIDATION

TYPE	MANUFACTURER	MODEL	LAMP	DESCRIPTION	
$ \downarrow \hspace{-0.2cm} \downarrow$	SURE-LITES	XR-9-C	(2)HALOGEN 12W	PPROVED BATTERY EM FIXTURE	
\otimes	ALPHA	EM-C SERIES	(2)7W FLUORESCENT	APPROVED SINGLE FACE EXIT SIGN	
\bigcirc		SINGLE FACE		BATTERY BACKUP 120V FIXTURE	


FIRE PREVENTION BUREAU EXIT SIGN SYMBOLS

SINGLE FACE EXIT SIGN
W/DIRECTIONAL ARROW


VIEW SIDE OF FIXTURE
W/DIRECTIONAL ARROW


SINGLE FACE EXIT SIGN
W/DIRECTIONAL ARROW

#12 SINGLE FACE EXIT SIGN
W/DIRECTIONAL ARROW

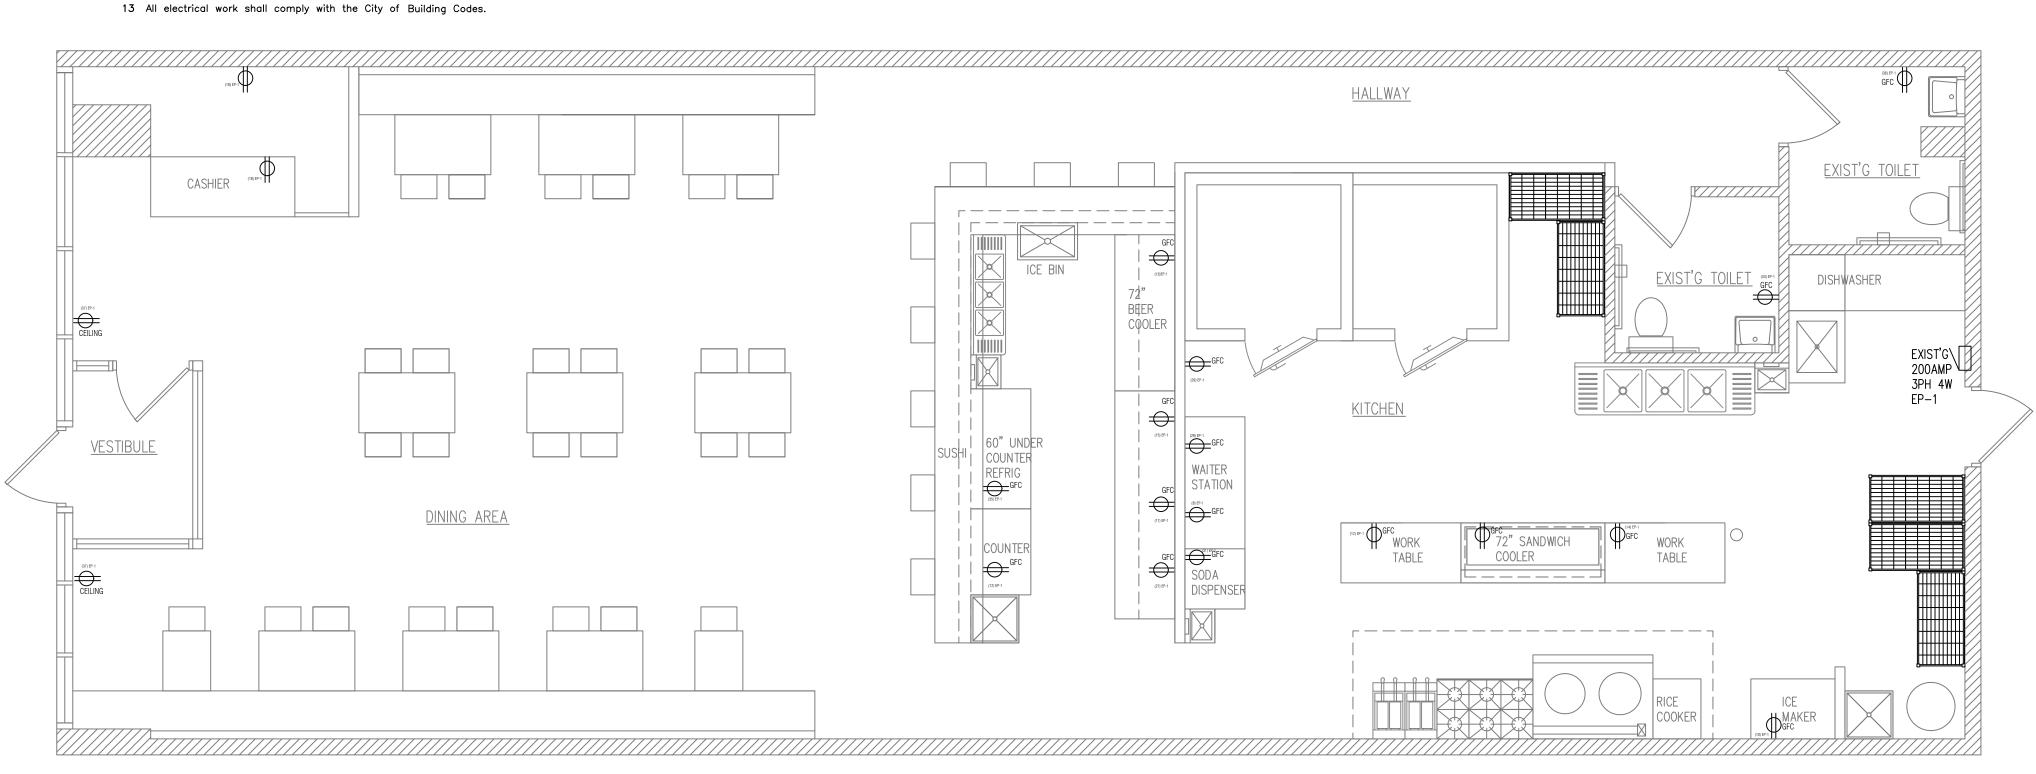

A ELECTRICAL POWER PLAN
SCALE 1/4"=1'-0"

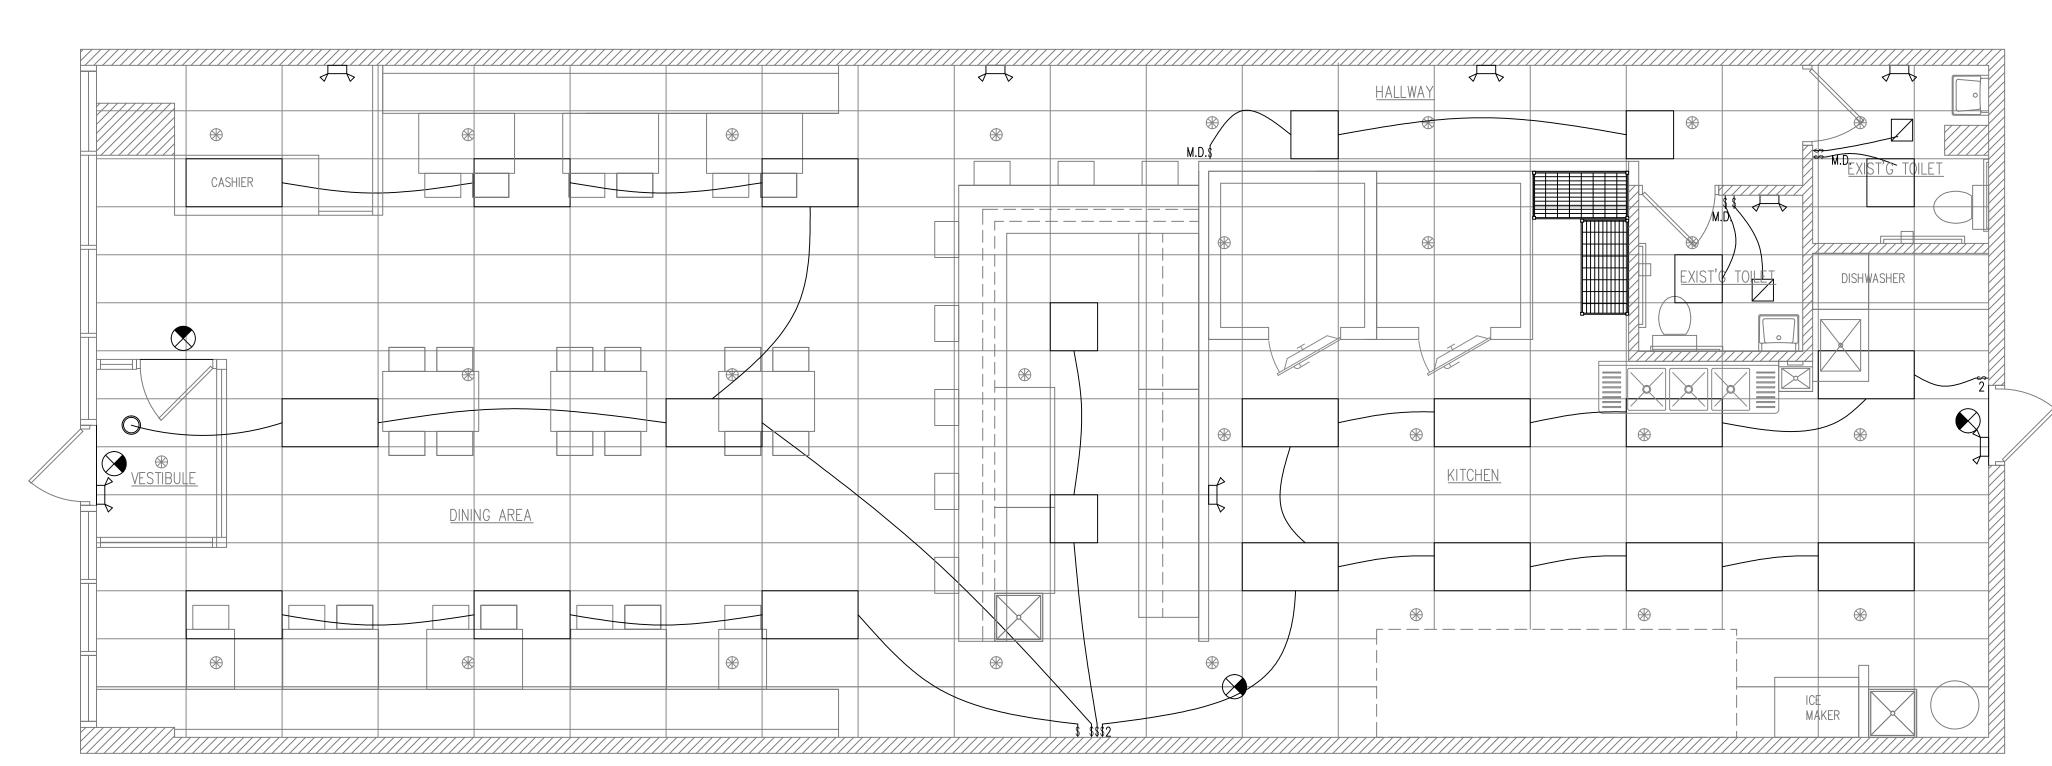

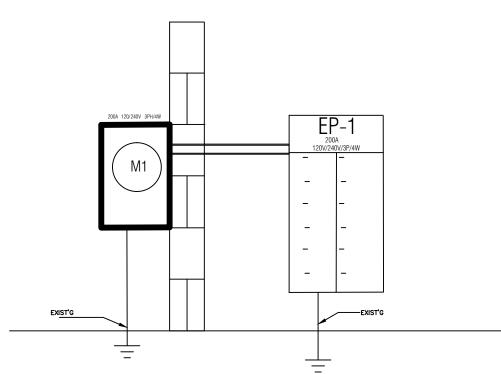

EXIST'S ELECTRICAL SERVICE DIAGRAM

Service Load Calculation Commercial

Rough Total Area: 2328 SQF'

Address: 955 WEST JACKSON STREET MORTON IL 61550 Outside Building Dimensions: Length <u>78'</u> Width <u>29'</u> Floors_1_

One Sets Electrical Service: 200A Phase 3 Wire 4 Volt 120/240

Ampere/s <u>200</u>

Service Conductors 14-28-1480 Size MCM Type CU (Al.,Cu),Conduit RMC IMC,Rigid

GENERAL LIGHTING LOAD:

Square foot area per floor: 2328 Total square foot area : 2328

4190

Times(3.0 Watts)per square foot X60% Other loads(receptacles)

(See section 14-16-180(b)) <u>5</u> Times(180 Watts) <u>900</u>

(1) Electrical Panel EP-1 240V/3PH/400A

TOTAL: 67820 VA

TOTAL LOAD: I = W/(v x 1.732)=163.5 (AMP)

USE 200 AMP MULTIPLY BY 80% FOR CONSIDERATIONS OF CONTINUOUS LOADS, SERVICE SIZE TO BE 160 AMP 120/208V 3 PH, 4 WIRE

ELECTRICAL SERVICE SIZE IS 200 AMP /120/240V/3PH/4W.

EXIST'G	ELECTRIC	CAL PANE	L "EP-1"	120/240V	3PH 4	W 200	AMP				
SERVES	С	В	А	AMPS	СК	СК	AMPS	Α	В	С	SERVE
WALK IN COOLER	1200			20	1	2	20	1080			DINNING AREA RECEPT
WALK IN GOULEN		1200		2	3	4	20		1000		DINNING LIGHT
WALK IN FREEZER	1888		1200	20	5	6	20			1000	DINNING LIGHT
VALIVIIVIIILLZEIT	1200			2	7	8	20	1080			KITCHEN RECEPT
DISHWASHER		3000		50	9	10	20		1080		KITCHEN RECEPT
DIOTIWACTIEN	8-		3000	2	11	12	20			1080	KITCHEN RECEPT
BEER COOLER	1250			20	13	14	20	1080			SANDWICH COOLER
				20	15	16	20	F	1250		SERVICE RECEPTAC
	1000			20	17	18	20			1080	SERVICE RECEPTAC
AC-1	3000			50	19	20	20	1080			SERVICE RECEPTAC
710 1		3000		2	21	22	20		1250		KEF
AC-2	**		2200	30	23	24	2	-		1250	TALL!
	2200			2	25	26	20	1200			KEF
WORK TABLE RECEPTACLE		1500		20	27	28	2		1200		INC.
SODA DISPENSER			1080	20	29	30	20	-		1250	MUA
ICE MAKER	1500			20	31	32	2	1250			-
UNDER COUNTER COOLER		1250		20	33	34	20		850		MAN'S TOILET ROO
	.==			15	35	36	20			850	WOMAN'S TOILET ROO
SIGN	550			20	37	38	20			360	EXIT/EMERGENCY LIGH
					39	40					
					41	42					
	10900	9950	7480					6770	6630	6870	
TOTAL PANEL LOAD	48600	VA	116.9	AMPS 3 PHA	SE						

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Phone: (312) 912-5798 Email: twarchitect98@yahoo.com

LICENSE NO: 001-022013 EXPIRES: 11/30/2022

> \geq INTERIOR

ISSUED FOR PERMIT



ELECTRICAL PLANS

SHEET NUMBER

B LIGHTING PLAN
SCALE 1/4"=1'-0"

VE	NTILATION	V SC	CHEDULE						
			MECHANICAL V	/ENTILATION	SERVED BY				
NUM	ROOM NAME	AREA	CODE		ACTUAL			02.1112001	
			OUTDOOR AIR	EXHAUST	SUPPLY	EXHAUST	RETURN	SUPPLY	EXHAUST
100	ENTRY	35	17		200			FN-1	
101	BAR AREA	280	200		2500X0.33 = 750CFM			FN-1	
					OUTDOOR AIR PROVIDED				
102	DINING AREA	1000	525		725CFM OUTDOOR AIR REQ'D		2000	FN-2	
103	KITCHEN	680	102	50	3000+700=3700	3750		FN-1,MUA-1	KEF-1,KEF-2
104	WOMEN'S	42		75 PER WC		120			TEF-1
105	MEN'S	42		75 PER WC		120			TEF-2
106	HALLWAY	108	6					FN-1	
	TOTAL		850		1000		2000		
				EXIST'G FN	-1 5TONS PROVIDE 2000X33%	= 600CFI	M FRESH	AIR THRU ROC)F.
				EXIST'G FN	-2 3.5TONS PROVIDE 1400X339	% = 400C	FM FRES	SH AIR THRU RO	OOF.
				TOTAL FRE	SH AIR 600+400 =1000CFM	PROVIDED)		

VICAL E	EQUIPMENT SCHE	DULE		
QTY.	MANUF.	MODEL	CFM	REMARKS
1	EXIST'G	EXIST'G(5.0TON)	2000	120,000 BTU IN /100,000 BTU OUT
1	EXIST'G	EXIST'G(3.5TON)	1400	80,000 BTU IN/60,000 BTU OUT
1	VENTILATION DIRECT	VXD85	1875	NEW KITCHEN HOOD EXHAUST FAN
1	VENTILATION DIRECT	VXD85	1875	NEW KITCHEN HOOD EXHAUST FAN
1	VENTILATION DIRECT	V2D.250-G15	3000	NEW TEMPERED MAKE UP AIR UNIT
1	BY OWNER	BY OWNER	120	TOILET ROOM EXHAUST FAN
1	BY OWNER	BY OWNER	120	TOILET ROOM EXHAUST FAN
	1	QTY. MANUF. 1 EXIST'G 1 EXIST'G 1 VENTILATION DIRECT 1 VENTILATION DIRECT 1 VENTILATION DIRECT 1 BY OWNER	1 EXIST'G EXIST'G(5.0TON) 1 EXIST'G EXIST'G(3.5TON) 1 VENTILATION DIRECT VXD85 1 VENTILATION DIRECT VXD85 1 VENTILATION DIRECT V2D.250-G15 1 BY OWNER BY OWNER	QTY. MANUF. MODEL CFM 1 EXIST'G EXIST'G(5.0TON) 2000 1 EXIST'G EXIST'G(3.5TON) 1400 1 VENTILATION DIRECT VXD85 1875 1 VENTILATION DIRECT VXD85 1875 1 VENTILATION DIRECT V2D.250-G15 3000 1 BY OWNER BY OWNER 120

TYPE 1 EXHAUST HOOD SPECIFICATIONS & EXHAUST HOOD FIRE PREVENTION NOTES VENTILATOR AND INSTALLATION SHALL COMPLY

WITH NFPA 96, NFS INTERNATIONAL, UL 710, 2006 IMC SECTIONS 507,508 & 509 IN ADDITION TO ALL LOCAL FIRE CODE.

TYPE 1 WALL MOUNTED EXHAUST CANOPY FOR COLLECTION ANCD REMOVAL OF GREASE AND SMOKE OVER RESTAURANT COOKING EQUIPMENT. HOOD MUST BE CAPABLE OF PROVIDING UP TO 90% MAKE UP AIR THROUGH A PERFORATED STAINLESS STEEL PLENUM.

THE RATIO OF EXHAUST-TO-MAKEUP AIR VALUES GIVEN SHALL NOT BE CHANGED WITHOUT PERMISSIONFROM THE BUILDING DIVISION. MAKE UP AIR SHALL BE PROVIDED WITHIN 10% OF THE EXHAUST VALUES.

HOOD MUST BE CONSTRUCTED OF NOT LESS THAN

16 GA. TYPE 304 STAINLESS STEEL. UNEXPOSED SURFACES SHALL BE CONSTRUCTED OF ALUMINIZED STEEL. ALL SEAMS, JOINTS AND PENETRATIONS SHALL HAVE A LIQUID TIGHT CONTINUOUS EXTERNAL WELD IN ACCORDANCE WITH NFPA 96. HOOD SHALL INCLUDE THE FOLLOWING: A DOUBLE INSULATED FRONT TO ELIMINATE CONDENSATION.THE HOOD SHALL BE CONSTRUCTED TO INCLUDE: A DOUBLE WALL INSULATED FRONT TO ELIMINATE CONDENSATION AND INCREASE RIGIDITY. THE INSULATION SHALL HAVE A FLEXURAL MODULUS OF 475 EL, MEET UL 181 REQUIREMENTS AND BE IN ACCORDANCE WITH NFPA 90A AND 90B.

AN INTEGRAL FRONT BAFFLE TO DIRECT GREASE LADEN VAPORS TOWARD THE EXHAUST FILTER BANK. AN INTEGRAL GREASE DRAIN SYSTEM ON THE HOOD BACK WITH A MINIMUM 1/8" PER FOOT SLOPE, TO INCLUDE AN EXPOSED, REMOVABLE 1/2 PINT GREASE CUP TO FACILITATE CLEANING.

A FRONT PLENUM, PROVIDING MAKE-UP AIR THROUGH PERFORATED STAINLESS STEEL DIFFUSER PLATES, DESIGNED TO PROVIDE EVEN AIR DISTRIBUTION A BUILT-IN WIRING CHASE FOR OUTLETS AND ELECTRICAL CONTROLS ON THE FRONT FACE OF THE HOOD DESIGNED TO AVOID PENETRATION OF THE CAPTURE AREA AND ELIMINATE THE NEED FOR AN EXTERNAL CHASEWAY. PROVIDE PERFORMANCE TEST RESULTS OF THE KITCHEN EXHAUST SYSTEM AT TIME OF FINAL INSPECTION. INDICATE FIRM DOING THE TESTING OF THE KITCHEN EXHAUST SYSTEM.

PROVIDE A TEST AND BALANCE REPORT OF THE

THE EXHAUST BLOWER SHALL CONTINUE TO RUN DURING THE OPERATION OF THE SYSTEM. THE MANUAL PULL STATION SHALL BE LOCATED 10'-25' FROM HOOD.

NOZZLES TO BE CAPPED & UNOBSTRUCTED. NOZZLE HEIGHTS FROM COOKING EQUIPMENT MIN. 12" MAX.

IF REQUIRED BY THE LOCAL FIRE MARSHALL THE KITCHEN EXHAUST HOOD DUCT SYSTEM TO BE CONNECTED TO FIRE ALARM AND TESTED.

UL INCANDESCENT LIGHT FIXTURES AND GLOBES, ALLOWING UP TO A 100 WATT STANDARD LIGHT BULB, INSTALLED AND PRE-WIRED TO A JUNCTION BOX AND INSTALLED WITH A MAXIMUM OF 4'-0" SPACING ON CENTER. EXHAUST DUCT COLLAR 4" HIGH WITH 1" FLANGE.

A MINIMUM OF FOUR CONNECTIONS FOR HANGER RODS. CONNECTORS SHALL HAVE 9/16" HOLES PRE-PUNCHED IN 1 1/2" X 1 1/2" ANGLE IRON AT THE FACTORY TO ALLOW FOR HANGER ROD CONNECTION BY OTHERS.

UL CLASSIFIED ALUMINUM BAFFLE FILTERS, WITH SIZE AND QUANTITY DETERMINED BY THE HOOD'S DIMENSIONAL PARAMETERS, BUT EXTENDING THE FULL LENGTH OF THE HOOD WITH FILLER PANELS NOT TO EXCEED 6".

CONTRACTOR TO PROVIDE EXHAUST HOOD WITH AN AUTOMATIC FIRE SUPPRESSION SYSTEM PER LOCAL BUILDING CODE.

KITCHEN HOOD EXHAUSTING SYSTEM SHALL BE

INTERLOCKED WITH MAKE-UP AIR SYSTEM TO BE CONTROLLED BY A SINGLE SWITCH TO PREVENT INDEPENDENT OPERATION. HOOD EXHAUST DUCTS SHALL NOT BE LESS THAN

14 GA. CARBON STEEL. ALL SEAMS, JOINTS AND


PENETRATIONS SHALL BE CONTINUOUS EXTERNAL


WELD AS LIQUID TIGHT. ALL ELECTRICAL WORK SHALL BE DONE BY LOCAL LICENSED ELECTRICIAN. THE EXHAUST DUCT SHALL BE ENCLOSED IN A MINIMUM ONE-HOUR SHAFT FROM THE POINT IT

PENETRATES THE CEILING TO THE POINT WHERE IT

TERMINATES OUTSIDE.

TYPE 1 HOODS TO HAVE INTERLOCK FANS WITH ANSUL SYSTEM. ANY ELECTRIC UNDER TYPE 1 HOOD TO HAVE SHUNT TRIP BREAKER WITH MANUAL RESET. ACCESS PANELS ARE REQUIRED FOR FIRE

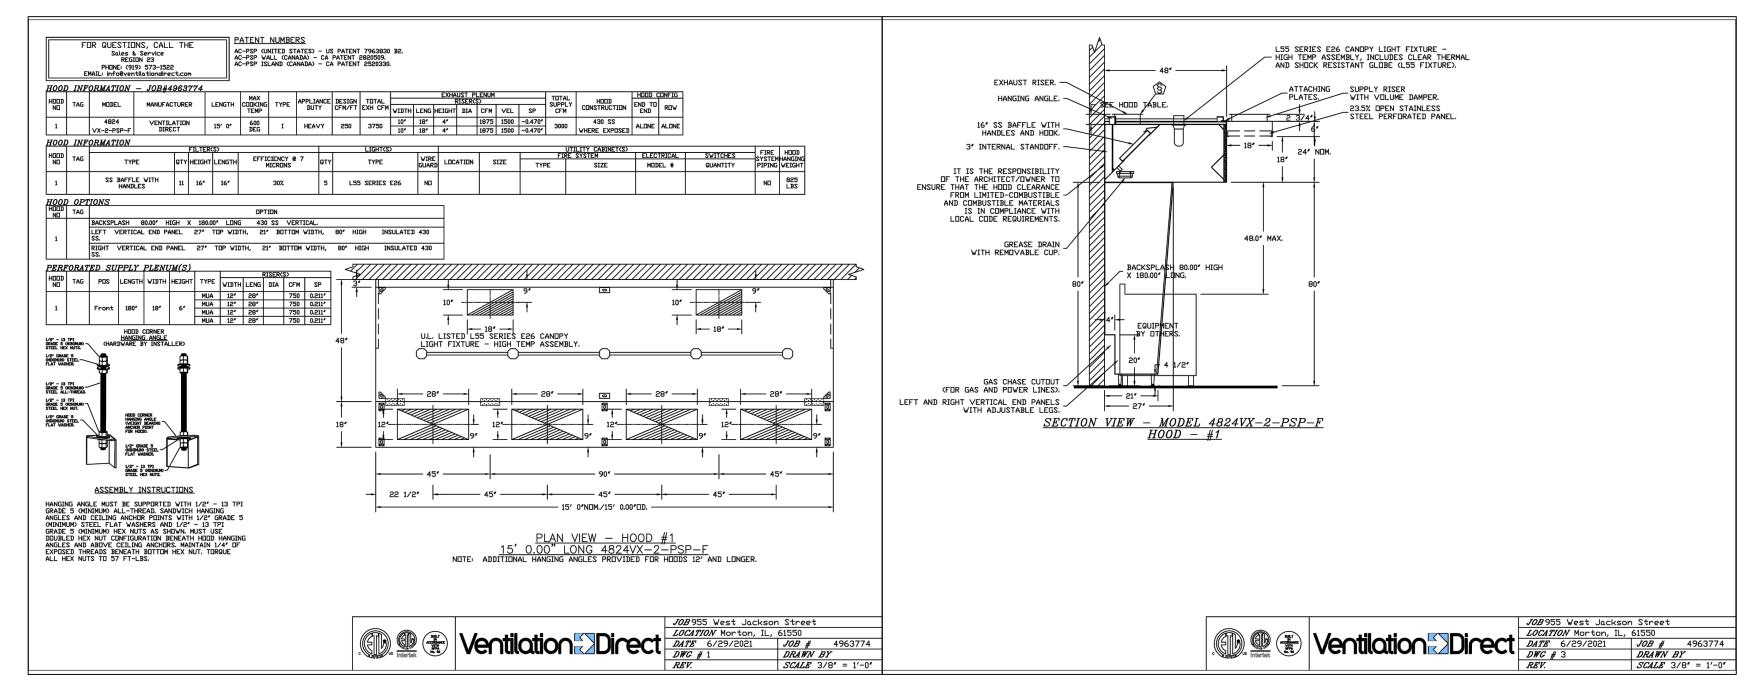

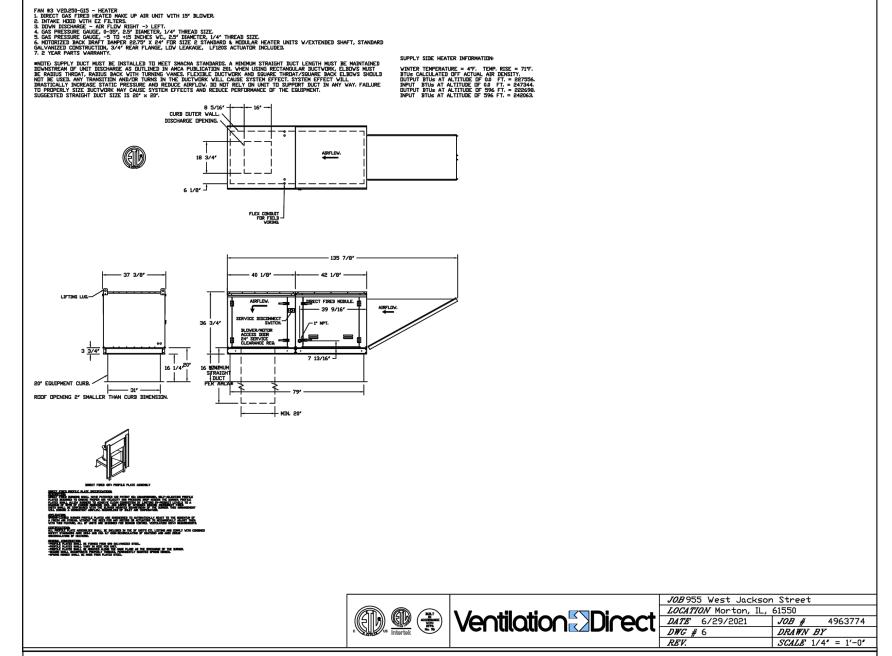

MECHANICAL PLAN & **SCHEDULES**

SHEET NUMBER

WEI TAN

🏸 CELL: 312-912-5798 🗧

WEI TAN

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Phone: (312) 912-5798

LICENSE NO: 001-022013

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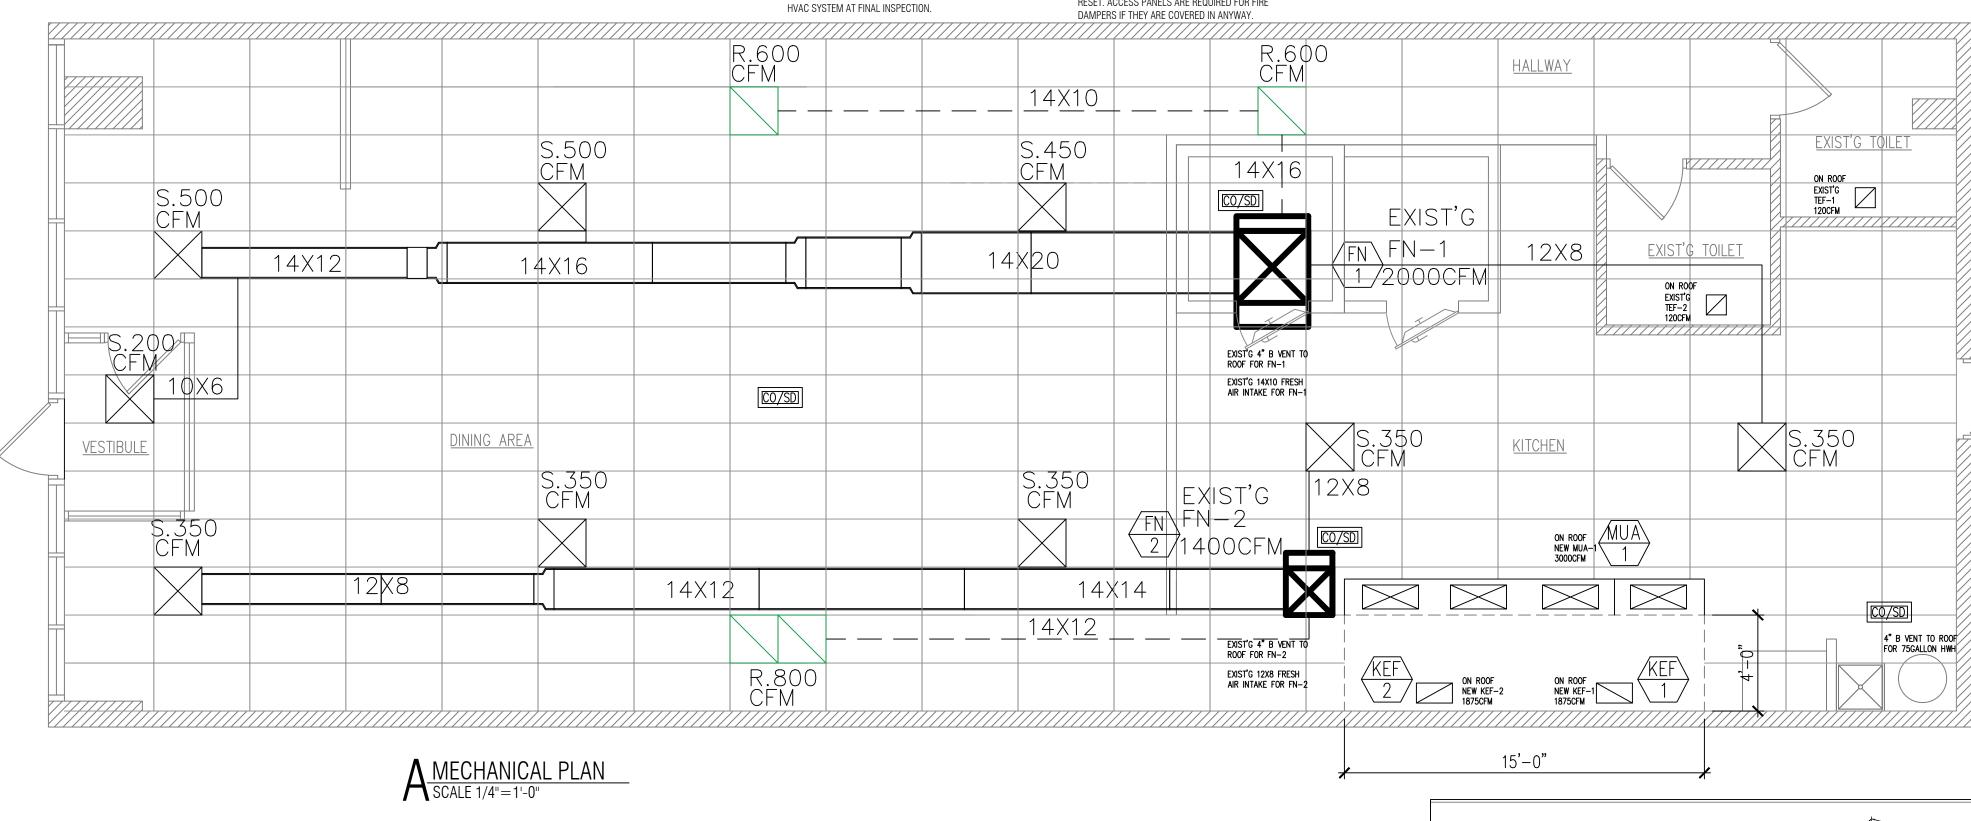
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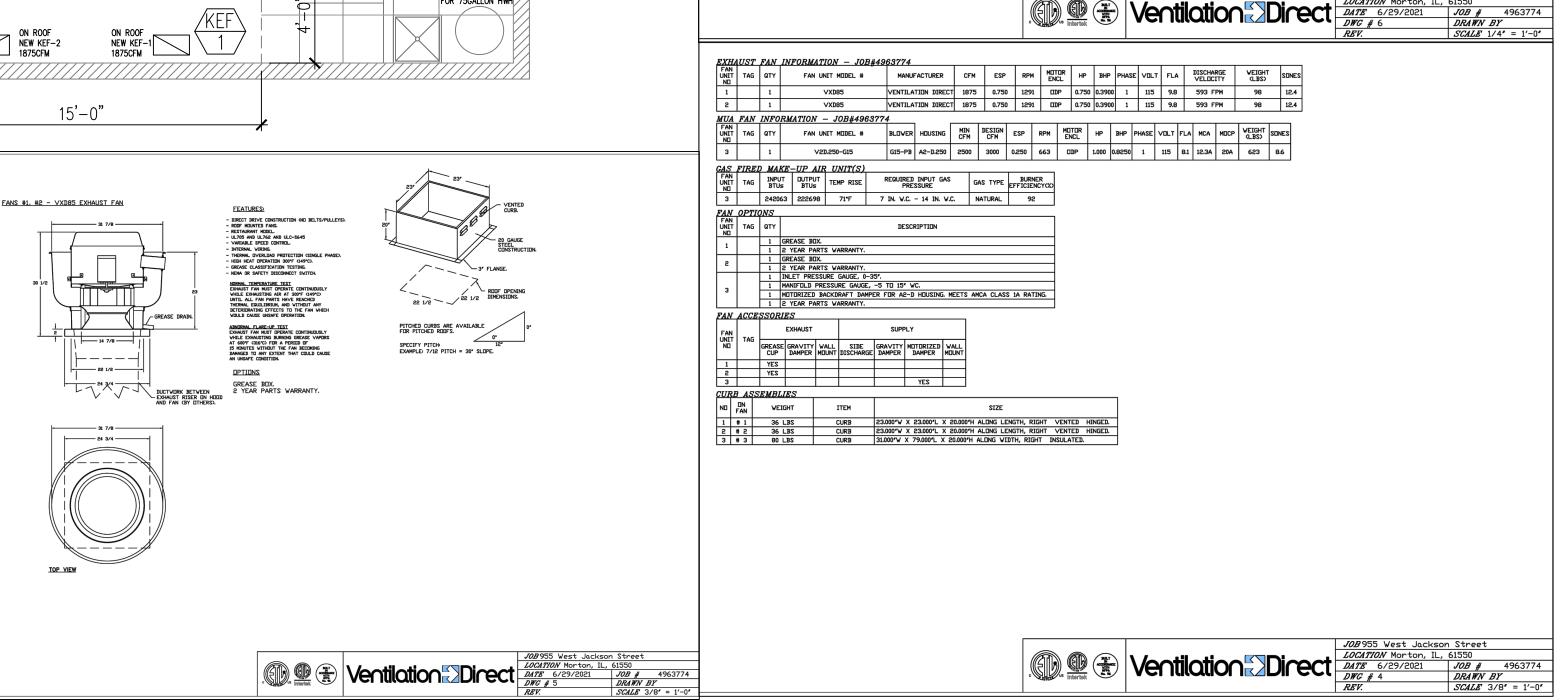
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PLUMBING

PLANS

WEI TAN

2425 S WENTWORTH AVE


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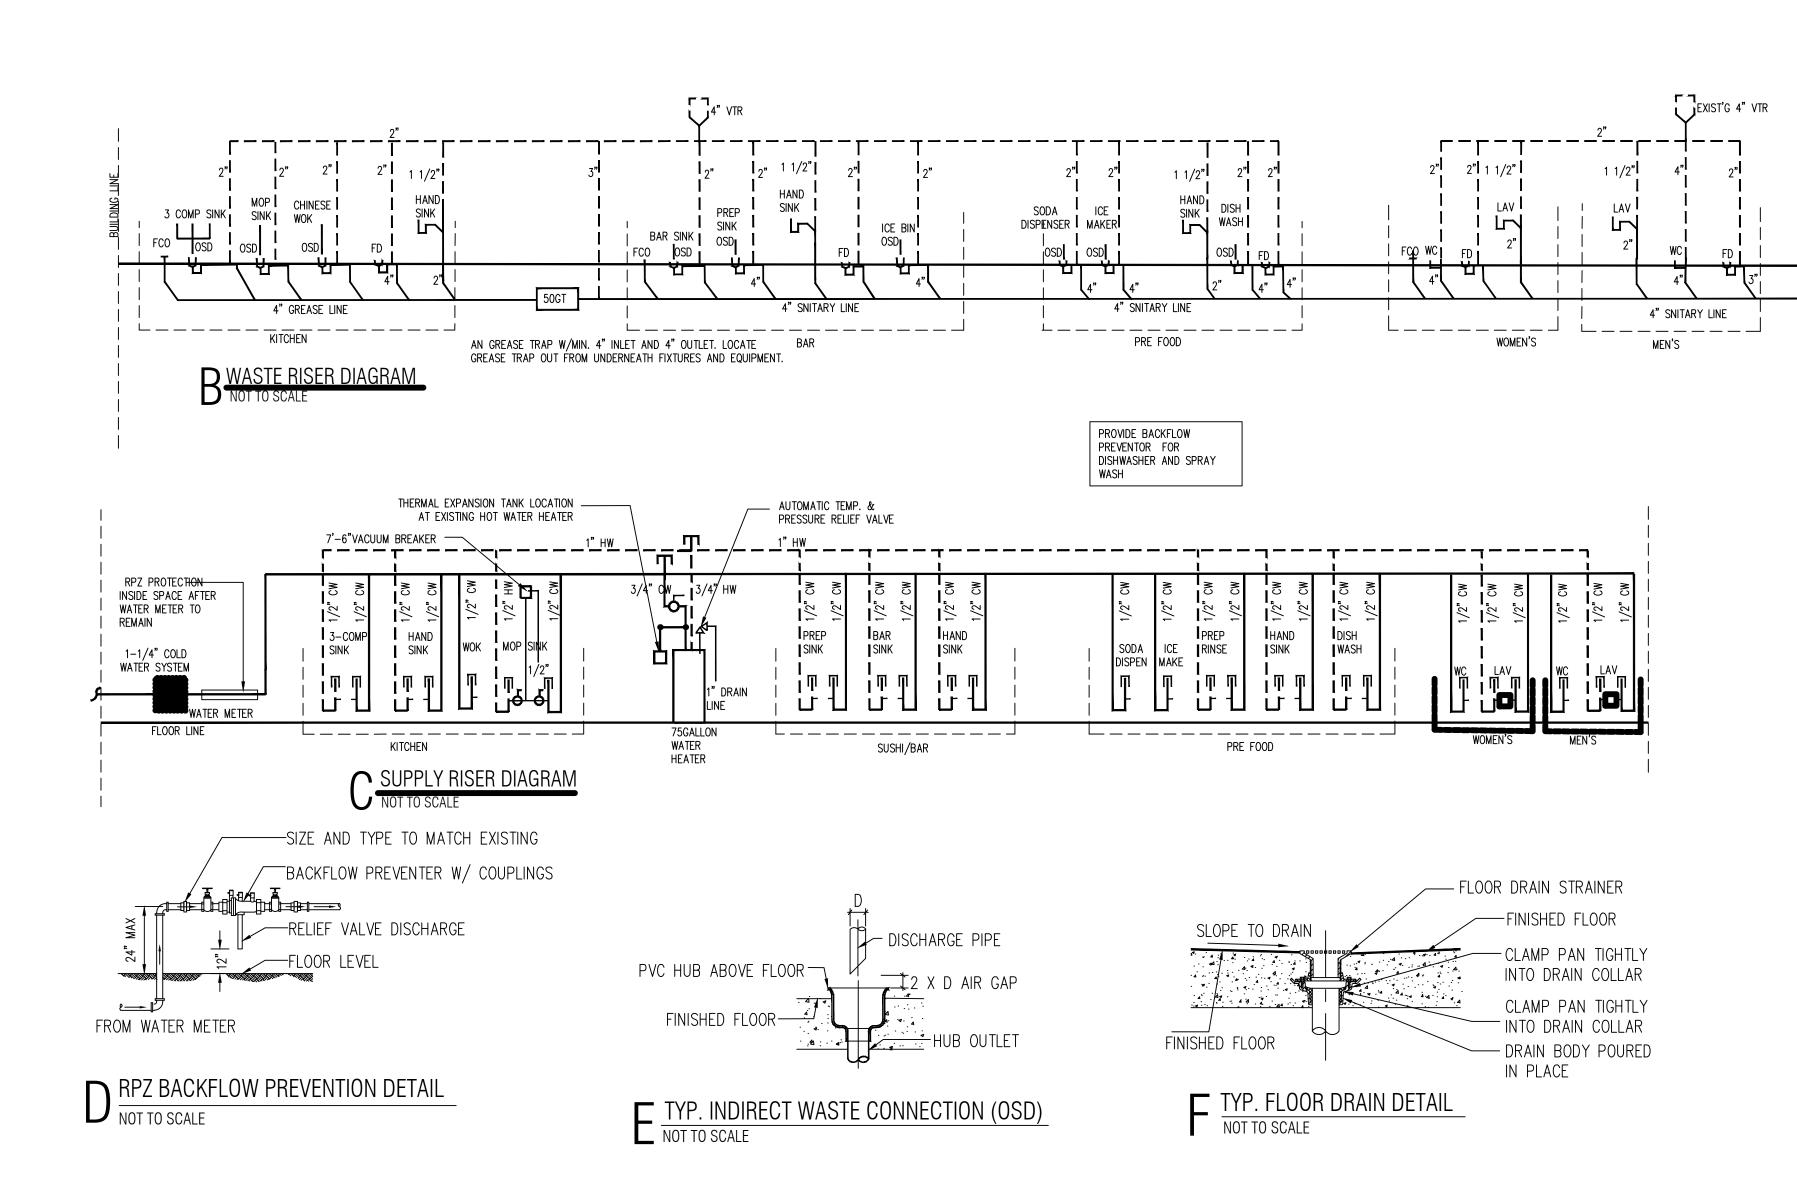
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CHICAGO IL 60616



PLUMBING PLAN SCALE 1/4"=1'-0"



PLUMBING FIXTURES AND FITTINGS SCHEDULE								
FIXTURE	MODEL	MODEL NO/ REMARKS						
WATER CLOSET	KOHLER	ADA COMPLAINT,FLOOR MOUNTED						
LAVATORY	KOHLER	ADA COMPLAINT,FLOOR MOUNTED						
TRASH RECEPTACLE	BOBRICK	B-275 WALL MOUNTED						
FAUCET	KOHLER	ADA COMPLAINT,ASME/ANSI 116/117 COMPLIANT,SET TO 110F MAX						
TEMPERING VALVE	WATTS	1170-M2						
TOILET PAPER DISPENSER	BOBRICK	B5288 ADA						
GRAB BARS	BOBRICK	B66806 SERIES, 36" AND 42"						
SOAP DISPENSER	BOBRICK	B82216 SURFACE MOUNTED						
MIRROR	BOBRICK	B-165 (ADA COMPLIANT)						

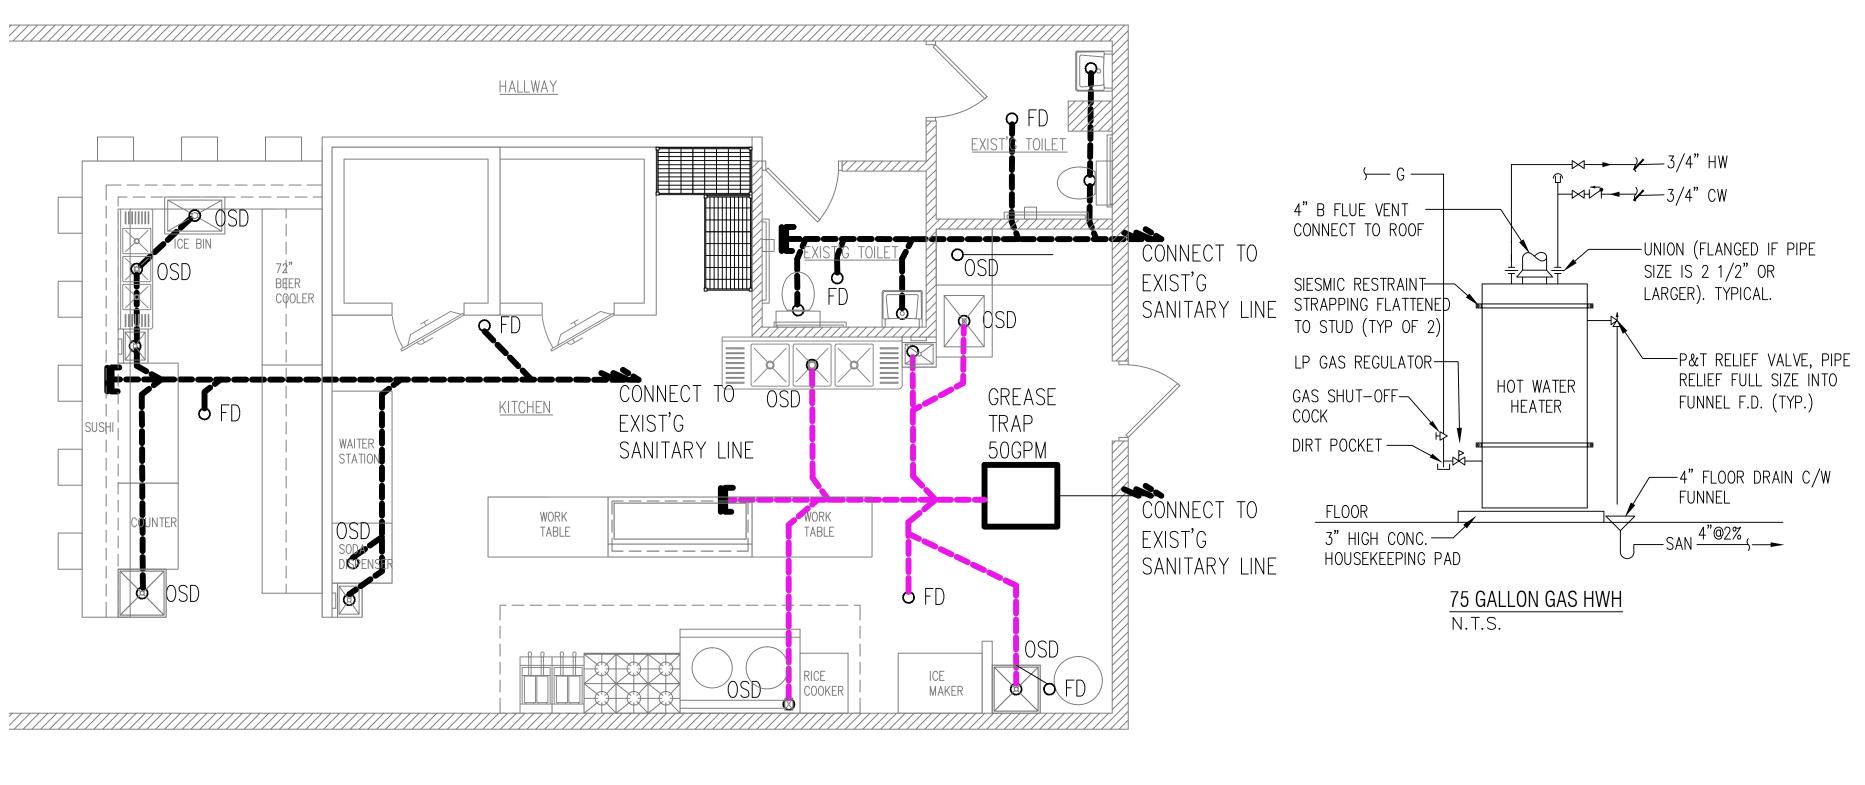VOL. (GAL.)
7
40
10
6
20
83 GAL.
UIREMENT: 83X60% = 50GPM

PLUMBING NOTICE.

ALL WATER INLETS MUST HAVE AN AIR GAP BETWEEN THE WATER INLET AND THE FIXTURE IT IS SERVING. THE AIR GAP MUST BE TWICE THE DIAMETER OF THE WATER INLET.

PROVIDE VACUUM BREAKERS ON SUBMERGED INLETS SUCH AS WATER CLOSETS, URINAL, DISH WASHER GARBAGE GRINDERS, MOP SINK FAUCET AND ANY THREADED WATER OUTLET. PROVIDE DOUBLE CHECK VALVES WITH ATMOSPHERIC VENTS OR REDUCED PRESSURE ZONED BACKFLOW PREVENTERS CAPABLE OF BEING SUBMERGED ON WATER INLETS WHERE YOU CANNOT INSTALL A VACUUM BREAKER AFTER THE LAST SHUT OFF VALVE OR SOLENOID SWITCH SUCH AS THE PRE-WASH SPRAYER.

VERIFY AIR GAP IN GRAVITY FLOAT OF THE ICE MACHINE. INSTALL WATTS 9D SERIES DUAL CHECK VALVE WITH INTERMEDIATE ATMOSPHERIC VENT BACKFLOW PREVENTOR

TO PREVENT BACKFLOW FROM CHEMICAL SYSTEM AT 3 COMP SINK, PROVIDE AN ECO-LAB PATHWAYS ELECTRONIC UNIT OR EQUIVALENT. THERE SHALL BE NO DRILLING OR TAPPING OF ANY PORTABLE WATER SUPPLY PIPE, FITTING OR FIXTURE FITTING FOR THE PURPOSE OF INTRODUCING SUCH CHEMICALS.

INDIRECT WASTE DRAINS ARE REQUIRED AT ALL THREE COMPARTMENT SINKS, DISHWASHERS, BAR SINKS, ICE MACHINES, SODA DISPENSERS, BEER TAPS, PREP SINKS, STEAM TABLES, WALK-IN COOLERS/FREEZERS CONDENSATE, OR ANY FOOD RELATED EQUIPMENT REQUIRING DRAINAGE.

ALL ABOVE GROUND SUPPLY WATER PIPING SHALL BE COPPER TYPE L. ABOVE GROUND WASTE / VENT PIPING SHALL BE SCHEDULE 40 PVC WITH PURPLE PRIMER ON ALL PVC JOINTS. UNDERGROUND SEWER PIPING TO BE MIN 4" SCHEDULE 40 PVC WITH PURPLE PRIMER ON ALL PVC JOINTS. CELL CORE PIPE IS NOT ALLOWED.

SEWER AND WASTE PIPING SHALL BE PRESSURE TESTED PER LOCAL PLUMBING CODE.

PLUMBING FIXTURES	NO.	LOAD VALVES IN WATER SUPPLY FIXTURES UN					
		COLD	HOT	TOTAL			
TOILET	2	3		6			
LAVATORY	2	1	1	4			
PREP SINK	1	3	3	4			
ICE MAKER	1	1		1			
DISHWASHER	1	3	3	4			
MOP SINK	1	3	3	4			
3-COMP SINK	1	3	3	4			
HAND SINK	3	1	1	6			
PREP RINSE	1	3	3	4			
CHINESE WOK SINK	1	1		1			
3-COMP BAR SINK	1	3	3	4			
TOTAL				42			

- HUB OUTLET

PLUMBING FIXTURES	QTY	COMMENT
WATER CLOSET	2	
LAVATORY	2	
HAND SINK	3	
ICE MAKER.	1	
PREP SINK	1	
3-COMP SINK	1	
DISHWASHER	1	
36" PRE RINSE	1	
MOP SINK	2	
75GALLON HWH	1	
3-COMP BAR SINK	1	
TOTAL	16	

ALLON HWH	1	
OMP BAR SINK	1	
AL	16	
		•
G NOTES		

FLOOR GRATE TO BE FASTENED DOWN — WITH SCREWS - DISCHARGE PIPE MOUNT FLUSH WITH FLOOR-FINISHED FLOOR — FLOOR SINK COVER FLUSH WITH TILE OR FLUSH WITH CONCRETE FLOOR IN AREA WITH NO TILE

TO EXISTING

SANITARY SYSTEM

 TYPICAL FLOOR SINK NOT TO SCALE

GAS PIPING

SUPPLIED VENT-LIMITING DEVICES. CONTRACTOR IS REQUIRED TO INSTALL SUCH DEVICES IN ACCORDANCE WITH THE MANUFACTURER'S INSTRUCTIONS TO MEET IFG 410.2 CODE AND TO MAINTAIN WARRANTY.

PROVIDE STEEL MESH VINYL COATED GAS LINES WITH QUICK DISCONNECTS ON ALL GAS FIRED EQUIPMENT.

ALL GAS PIPE AND FITTINGS TO BE SCHEDULE 40 BLACK GAS PIPE WITH GAS VALVES AT EACH APPLIANCE. KITCHEN EQUIPMENT MUST HAVE APPROVED GAS CONNECTORS.

ALL EQUIPMENT SPECIFIED COME WITH MANUFACTURER

