GENERAL PROJECT NOTES

SUMMARY OF WORK

INTERIOR REMODELING OF THE EXISTING 2420SF SPACE TO PROVIDE A RESTAURANT SERVICE. PROVIDE ALL NECESSARY ARCHITECTURAL ELECTRICAL, HVAC AND PLUMBING WORK AS NOTED.

GENERAL INSTRUCTIONS

THESE DRAWINGS ARE SCOPE DOCUMENTS INDICATING THE GENERAL PROJECT DESIGN CONCEPT, DIMENSIONS OF THE PROJECT, MAJOR ARCHITECTURAL ELEMENTS, AND BASIC ORGANIZATION OF MECHANICAL, ELECTRICAL AND PLUMBING SYSTEMS. AS SCOPE DOCUMENTS, THESE DRAWINGS DO NOT NECESSARILY DESCRIBE OR INDICATE ALL MATERIALS OR WORK REQUIRED FOR FULL PERFORMANCE AND COMPLETION OF THE PROJECT. ON THE BASIS OF THE GENERAL SCOPE INDICATED OR DESCRIBED, THE CONTRACTOR(S) SHALL FURNISH ALL ITEMS REQUIRED FOR PROPER EXECUTION AND COMPLETION OF THE PROPOSED PROJECT. THE ARCHITECT IS NOT RESPONSIBLE FOR THE FAILURE OF THE CONTRACTOR(S) TO EXECUTE NECESSARY WORK OR TO SUPPLY REQUIRED MATERIALS FOR PROPER COMPLETION OF THIS PROJECT. FURTHER MORE THE ARCHITECT MAKES NO WARRANTY EXPRESSED OR IMPLIED ON THESE DOCUMENTS

DUE TO THE NATURE OF THIS WORK THE ARCHITECT DOES NOT WARRANT THE EXISTING CONDITIONS AS DEPICTED IN THESE DRAWINGS AS BUILT CONDITIONS. THE MEASUREMENTS ON THESE DRAWINGS ARE REASONABLY ACCURATE FOR THE PURPOSE OF "FIGURING." HOWEVER, IN THE EXECUTION OF WORK ON THE JOB, DO NOT SCALE DRAWINGS. EACH CONTRACTOR IS REQUIRED TO VERIFY ALL DIMENSIONS WITH THE ACTUAL CONDITIONS AND TO REPORT ANY DISCREPANCIES TO THE ARCHITECT, OWNER, OR THE OWNER'S REPRESENTATIVE.

CONTRACTOR SHALL OBTAIN AND PAY FOR ANY PERMITS AND FEES REQUIRED TO PERFORM THE WORK, UNLESS DIRECTED OTHERWISE BY

EACH CONTRACTOR SHALL BE RESPONSIBLE FOR STORAGE AND SAFETY OF HIS OWN MATERIALS AND WORK, AND FOR PROPERLY REMOVING HIS DEBRIS FROM THE JOB SITE. GENERAL CONTRACTOR (GC) SHALL PROVIDE FOR ALL SITE DEMOLITION AND DEBRIS REMOVAL REQUIRED TO PERFORM NEW CONSTRUCTION WHILE ADEQUATELY MAINTAINING THE PREMISES AND ADJACENT PREMISES TO INSURE NORMAL OCCUPANCY AND SECURITY. THE GC SHALL COORDINATE PROPER TRANSPORTATION AND STORAGE OF BUILDING MATERIALS ON THE SITE TO AVOID OVERLOADING OF EXISTING FLOOR.

CONTRACTORS INSTALLING PIPES, DUCTS AND CONDUIT WILL BE REQUIRED TO DO ALL CUTTING AND PATCHING IN CONNECTION WITH THEIR WORK, INCLUDING EXCAVATION AND DIGGING. THE OWNER WILL ASSUME NO RESPONSIBILITY FOR THE COST OF CHANGES OR EXTRA WORK MADE NECESSARY BY THE FAILURE OF TRADES TO COORDINATE THEIR WORK DURING CONSTRUCTION.

WHERE APPLICABLE THE GC SHALL CONSTRUCT PHYSICAL BARRIERS AROUND AREAS UNDER CONSTRUCTION AS REQUIRED TO ENSURE GENERAL PUBLIC AND PERSONAL SAFETY.

THE GC SHALL SUPERVISE AND DIRECT THE WORK. HE SHALL BE SOLELY RESPONSIBLE FOR ALL CONSTRUCTION MEANS, METHODS, TECHNIQUES, SEQUENCES AND PROCEDURES. THE GC SHALL BE RESPONSIBLE FOR COORDINATING ALL PORTIONS OF THE WORK UNDER HIS CONTRACT. ALL WORK SHALL BE COMPLETED USING PRACTICES ACCEPTED AND ENDORSED BY THE CORRESPONDING TRADE INDUSTRIES.

THE TERM "PROVIDE" SHALL MEAN TO FURNISH AND INSTALL.

THE CONTRACT AND SUBCONTRACT AMOUNTS SHALL PROVIDE COMPLETE WORKING MECHANICAL, ELECTRICAL AND PLUMBING SYSTEMS COMMENSURATE WITH THE REQUIREMENTS OF THE CONTRACT DOCUMENTS AND THE APPLICABLE CODES.

WHEN WALLS ARE TO BE "ALIGNED", THE ALIGNMENT OF SUCH WALLS IS TO THE OUTSIDE FINISHED SURFACE, SUCH AS DRYWALL SURFACE.

ALL DIMENSIONS SHOWN ARE TO FINISH FACE OF WALL UNLESS NOTED OTHERWISE. DIMENSIONS AND NOTES FOR A GIVEN CONDITION ARE TYPICAL FOR ALL SIMILAR CONDITIONS UNLESS NOTED OTHERWISE.

WHERE NEW WORK ADJOINS EXISTING, ALL SUCH NEW WORK SHALL BE PROPERLY INTERGRATED WITH THE EXISTING TO ENSURE UNIFORM APPEARANCE. ANY REPAIR WORK REQUIRED TO EXISTING WORK SHOULD BE TAKEN CARE OF BY THE CONTRACTOR - PROVIDING ALL NECESSARY CUTTING, FITTING AND PATCHING AND SHALL FURNISH ALL NECESSARY LABOR AND MATERIALS FOR THIS WORK. ALL WORK REQUIRING SPECIAL DETAILING, AND NOT DETAILED ON THE DRAWINGS SHOULD BE BROUGHT TO THE ATTENTION OF THE ARCHITECT / OWNER.

THE GENERAL CONTRACTOR SHALL COORDINATE ALL TRADES TO AVOID INTERFERENCE, TO PRESERVE MAXIMUM HEADROOM, AND AVOID OMISSIONS.

THE ARCHITECT HAS NO CONTRACTUAL DUTY TO CONTROL MEANS AND METHODS OF THE WORK NOR TO PROVIDE JOB SITE SUPERVISION, ENSURE SAFETY OR CONSTRUCTION MANAGEMENT AND DOES NOT VOLUNTARILY ASSUME ANY SUCH RESPONSIBILITIES.



ACCESSIBILITY REQUIREMENTS

TOILET ROOMS REQUIRED TO BE ACCESSIBLE SHALL CONFORM TO ALL ACCESSIBILITY REQUIREMENTS OF THE AMERICANS WITH DISABILITIES ACT WHICH INCLUDES, BUT IS NOT LIMITED TO THE FOLLOWING:



ACCESSIBILE SIGNAGE

- 1: Per IFC 904 a commercial hood and duct system shall be installed. This shall include the proper hood extinguishing system. The hood contractor shall apply for and pull a separate permit for the
- 2: The hood tests shall be witnessed. Testing shall be scheduled with the Fire Safety Division and Mechanical inspector at least 24 hours in advance for all tests.
- 3: The occupancy load shall be posted at the entrance for all assembly type occupancies. 4: There shall be a Class K fire extinguisher in the kitchen within the guidelines set forth in section 904.11.5 of the IFC.

CLOSER

— PAPER TOWEL DISPENSER

-TOILET PAPER

ALLOWANCE


DOOR MANEUVERING CLEARANCE

-ELEC OUTLET

LEVER STYLE FAUCET AT LAV.

SOAP -DISPENSER

5'-0" TURNING RADIUS

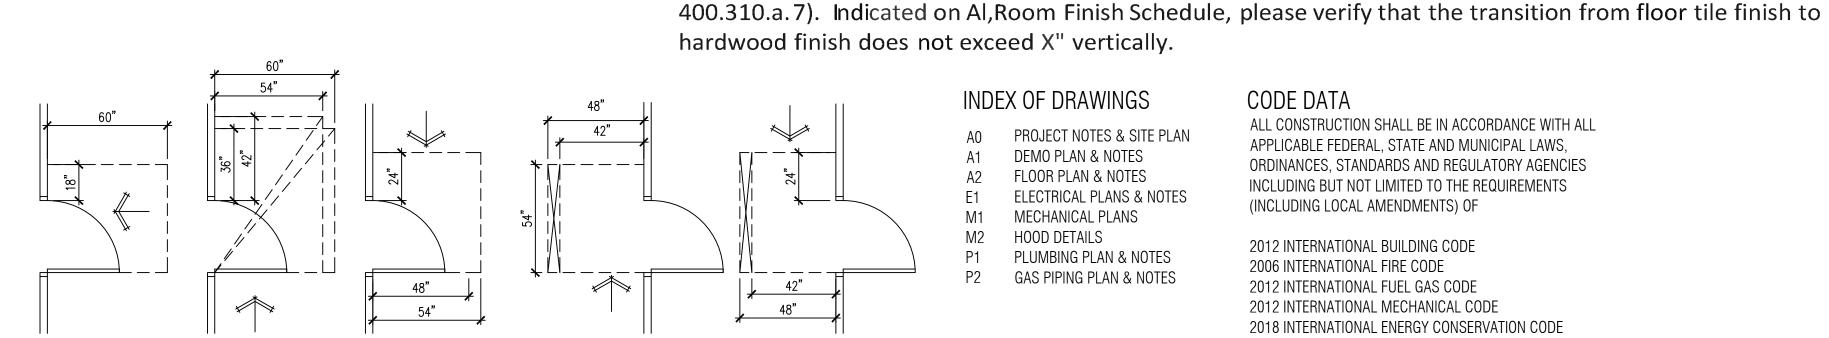

ACCESSIBLE -

SIGNAGE

INDEX OF DRAWINGS

PROJECT NOTES & SITE PLAN DEMO PLAN & NOTES

the IBC section 803 (IBC 8012). Interior Exit Passageway

in a non-sprinklered B use must be Class A when tested in accordance with ASTM E84 of UL 723.

- FLOOR PLAN & NOTES **ELECTRICAL PLANS & NOTES** MECHANICAL PLANS
- HOOD DETAILS

PLUMBING PLAN & NOTES GAS PIPING PLAN & NOTES

PROJECT DATA USE GROUP CLASSIFICATION A-2 **CONSTRUCTION TYPE** TOTAL FLOOR AREA 2420SF EXIT ACCESS TRAVEL DISTANCE 75 FT MAXIMUM

of not more than 450

AUTOMATIC SPRINKLERS 76 FIXED SEATING OCCUPANTS DINING AREA OCCUPANTS WAITING AREA 120SF / 15 = 8 OCCUPANTS KITCHEN AREA OCCUPANTS 6 OCCUPANTS 90 OCCUPANTS TOTAL OCCUPANT LOADS MAXIMUM HEIGHT 1 STORY REQUIRED NUMBER OF EXITS: ACTUAL 4 MINIMUM CORRIDOR WIDTH

Exposed and concealed insulation shall have a flame spread index of not more than 25 and a smoke development index

wall and or Ceiling Finishes meet the Fire Performance and Smoke Development requirements of

The Means of Egress, including the Exit Discharge, shall be illuminated at all times the building is occupied (IBC 1006.1).

Ground and floor surfaces along accessible routes cannot have changes in level over X'' and be vertical (IAC

ADA SEATING REQUIREMENTS

. Wheelchair Seating Area: Min 30" E. Tabletop Height: 28 - 34

CODE DATA ALL CONSTRUCTION SHALL BE IN ACCORDANCE WITH ALL APPLICABLE FEDERAL, STATE AND MUNICIPAL LAWS, ORDINANCES, STANDARDS AND REGULATORY AGENCIES INCLUDING BUT NOT LIMITED TO THE REQUIREMENTS (INCLUDING LOCAL AMENDMENTS) OF

2012 INTERNATIONAL BUILDING CODE 2006 INTERNATIONAL FIRE CODE 2012 INTERNATIONAL FUEL GAS CODE 2012 INTERNATIONAL MECHANICAL CODE 2018 INTERNATIONAL ENERGY CONSERVATION CODE 2011 NATIONAL ELECTRICAL CODE 2014 ILLINOIS STATE PLUMBING CODE 2018 ILLINOIS ACCESSIBILITY CODE 2000 NFPA 101 LIFE SAFETY CODE

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SSUED FOR PERMIT	12/18 /2022

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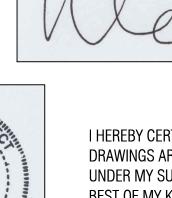
PROJECT NOTES

SHEET NUMBER

WEI TAN 001-022013

I HEREBY CERTIFY THAT THESE DRAWINGS ARE PREEPARED BY ME OR UNDER MY SUPERVISION AND TO THE BEST OF MY KNOWLEDGE CONFORM WITH APPLICABLE CODES.

LIC EXPIRES NOV 30, 2024



 TYPICAL ACCESSIBILITY REQUIREMENTS NOT TO SCALE


LAVATORY

TOILET FLUSH VALVE ON OPEN (WIDE) SIDE

NOT TO SCALE

IAC 400.310(N)(4)

ACCESSIBILE MOUNTING HEIGHTS

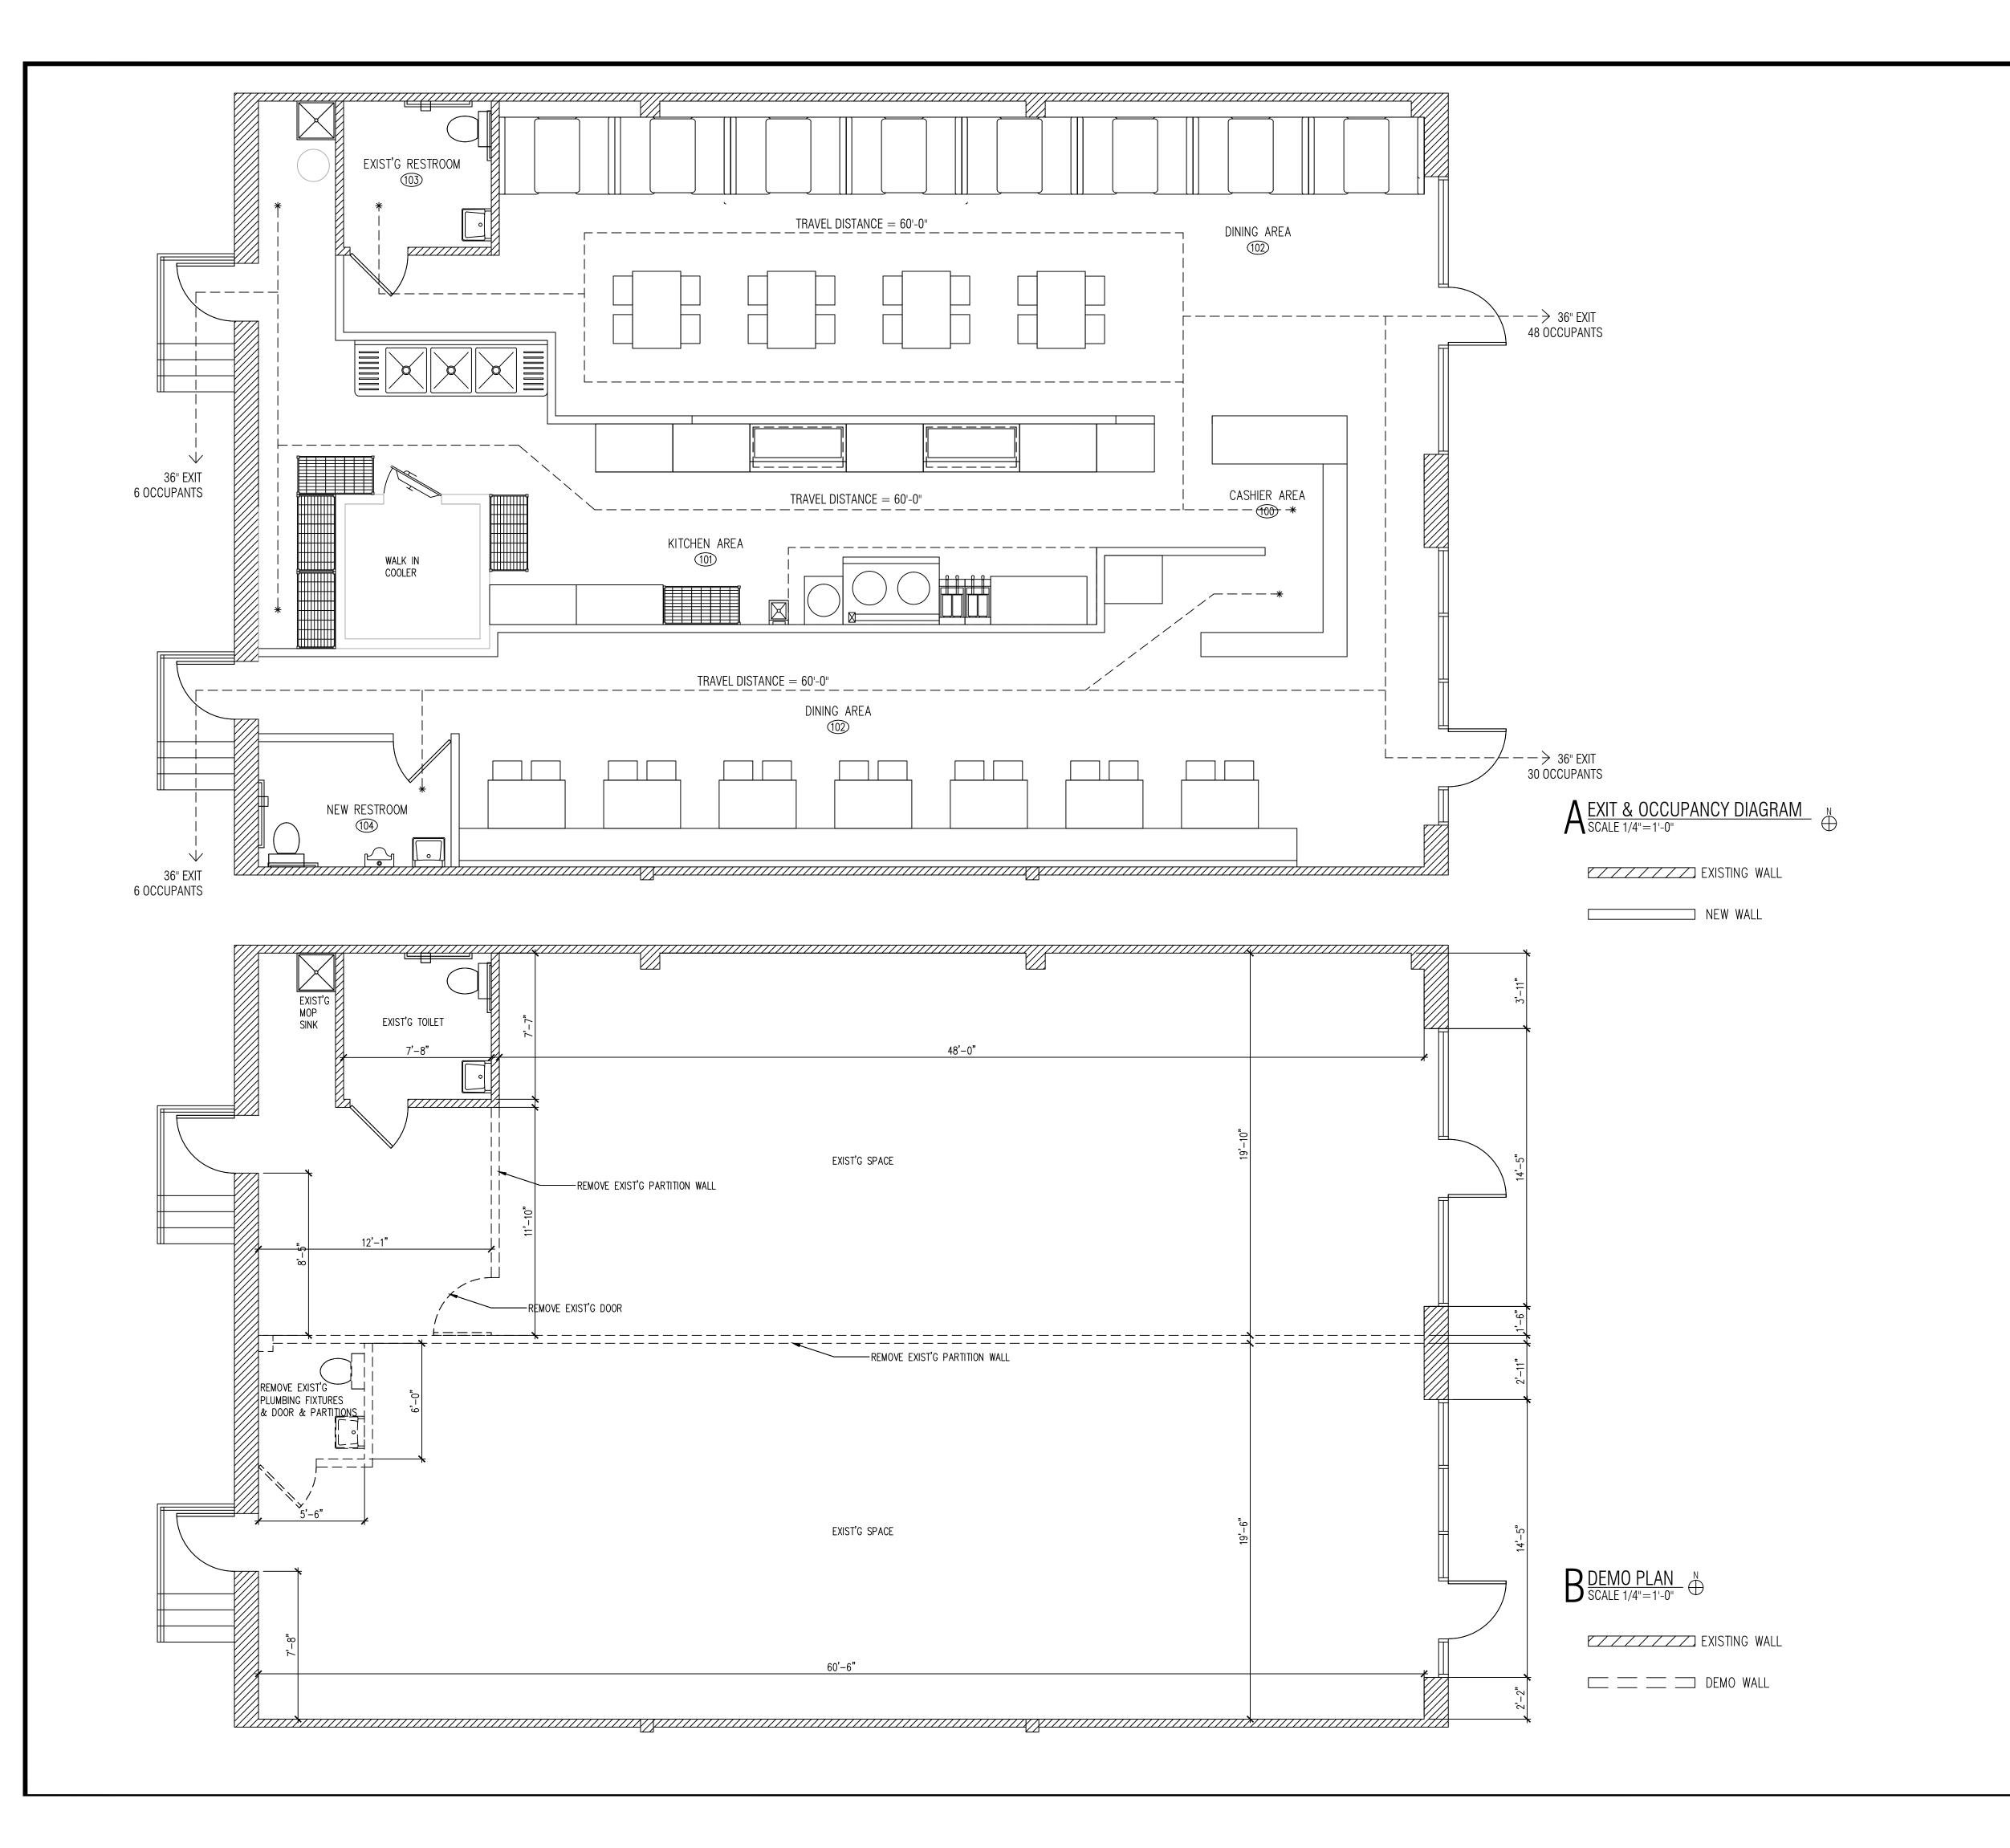

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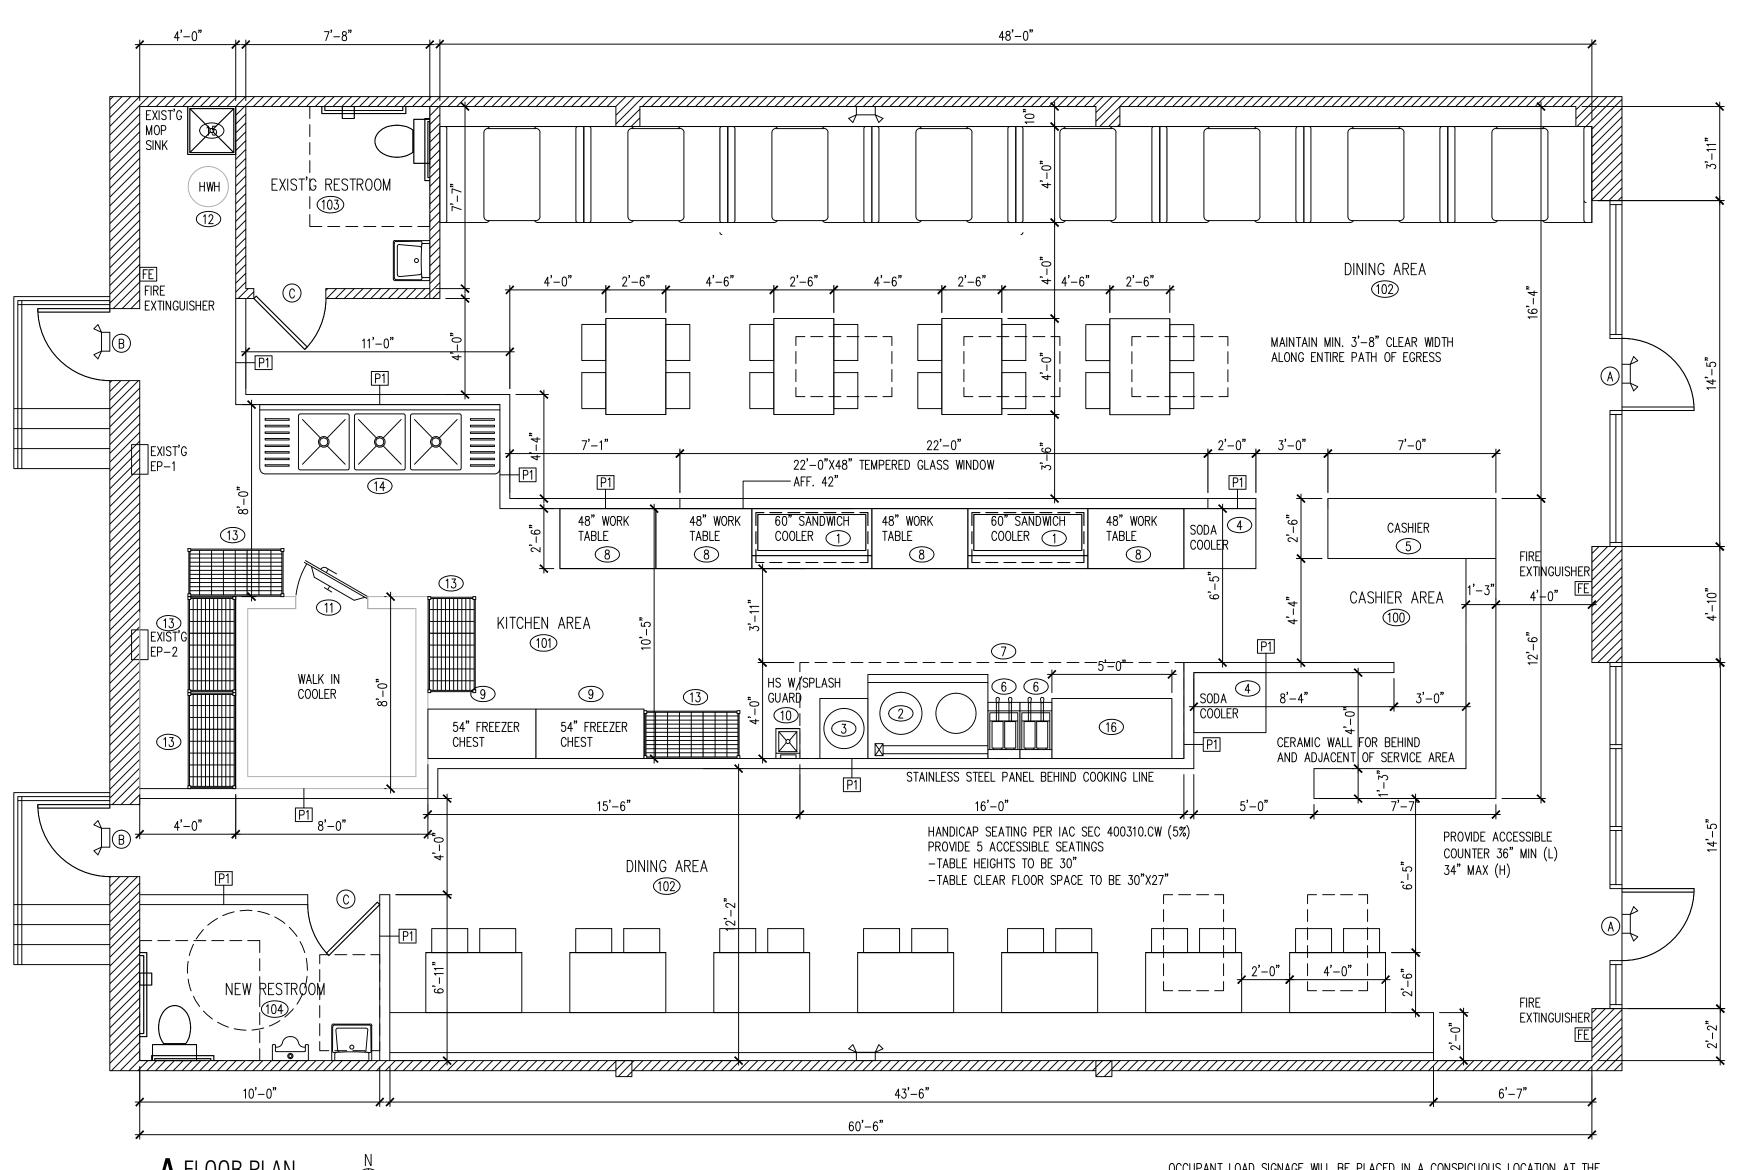
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DEMO PLAN & NOTES

SHEET NUMBER

A1




FLOOR PLAN
SCALE 1/4"=1'-0"

NEW WALL

OCCUPANT LOAD SIGNAGE WILL BE PLACED IN A CONSPICUOUS LOCATION AT THE ENTRANCE TO THE RESTAURANT AND EACH ASSEMBLY SPACE.

THE EXIT DOORS ARE EQUIPPED WITH PANIC HARDWARE.IBC 1008. 1. 9

EMERGENCY AND GENERAL EGRESS DISCHARGE LIGHTING. IBC 1006.1 ON SHEET E1

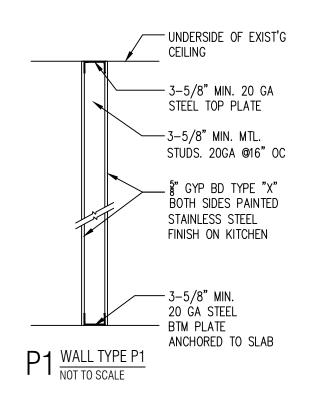

NO	QTY	DESCRIPTION	GAS	ELECT	RIC	PLUMBING	REMARKS
1	2	SANDWICH COOLER	-	120V	4A		NSF
2	1	CHINESE WOK	1.5"	_	_	1/2" CW,4" INDIRECT DRAIN	NSF, 220000 BTU
3	1	RICE COOKER	3/4"		-	-	NSF,35000BTU
4	2	SODA COOLER	-	120V	4A	-	NSF
5	1	CASHIER COUNTER	-	-	-	-	NSF
ô	2	DEEP FRYER	3/4"	-	_	-	NSF, 110000 BTU
7	1	16'-0"X4'-0" EXHAUST HOOD,TYPE I	-	-	-	-	U.L. W/ANSUL FIRE SUPPRESSION SYSTEM
8	4	WORK TABLE	_	_	_	-	NSF,W/ 6" STAINLESS STEEL LEGS NSF APPROVED
9	2	54" FREEZER CHEST	-	120V	5A	-	NSF
10	1	HAND SINK	_	-	_	1/2" CW,1/2" HW, 2" DRAIN	NSF, WALL MOUNTED - SEALED
11	1	8'-0" X 8'-0" WALK IN COOLER	-	240V	12A	-	NSF
12	1	HOT WATER HEATER	3/4"	120V	-	3/4" CW,3/4" HW	NSF, 50GALLONS
13	5	STAINLESS SHELVING	-	-	-	-	NSF APPROVED STAINLESS STEEL SHELVING
14	1	3 COMPARTMENT SINK	_	_	_	1/2" CW,1/2" HW,4" INDIRECT DRAIN	NSF,W/ ECOLAB PATHWAY TO PREVENT BACKFLOV
15	1	MOP SINK	_	-		1/2"CW,1/2" HW, 4"DRAIN	NSF, W/ MOP HOOKS, SEAL EDGES
16	1	GRIDDLE	3/4"	_	-	_	NSF, 110000 BTU

KITCHEN EQUIPMENT NOTES

CONTRACTOR SHALL INSTALL AND CONNECT ALL EQUIPMENT AS PER EQUIPMENT SUPPLIER'S SPECIFICATIONS. ALL LOCATIONS TO BE VERIFIED WITH OWNER PRIOR TO INSTALLATION.

PLUMBING CONTRACTOR SHALL PROVIDE ALL ROUGH-INS.
INSULATE ALL COLD/HOT WATER PIPES AS REQUIRED. MAINTAIN
MIN 36" IN FRONT OF ALL COOKING EQUIPMENT.

ELECTRICAL CONTRACTOR SHALL PROVIDE ALL ELECTRICAL OUTLETS FOR EQUIPMENT. VERIFY ALL ELECTRICAL REQUIREMENTS WITH EQUIPMENT SUPPLIER. VERIFY ALL GAS AND WATER REQUIREMENTS WITH EQUIPMENT SUPPLIER.

ALL PERMANENT EQUIPMENT MUST BE LOCATED SO THAT AREAS BEHIND, UNDERNEATH, AND ON THE SIDES OF THE EQUIPMENT CAN BE EASILY CLEANED.

TWO DRAIN BOARDS ARE REQUIRED AT ALL THREE-COMPARTMENT SINKS ALONG WITH AN APPROPRIATELY SIZED FAUCET, LOCKABLE DRAIN PLUGS, AND AN INDIRECT CONNECTION TO THE SEWER.

DRY STORAGE

DRY STORAGE : 25% OF 600 SF (KITCHEN AREA.) =150SF REQ'D ACTUAL DRY STORAGE 5X4'X2'X4= 160SF PROVIDED .

ALL FOOD AND FOOD RELATED ITEMS MUST BE STORED OFF THE FLOOR ON DURABLE WASHABLE SHELVES. THE STORAGE AREA MUST BE APPROPRIATELY SIZED BASED ON THE NUMBER OF MEALS SERVED DAILY AND THE NUMBER OF DELIVERIES WEEKLY.

ALL FOOD EQUIPMENT TO BE ON CASTERS, 6" LEGS, OR SEALED TO THE FLOOR FOR EASY CLEANING.

NO RAW WOOD SURFACES PERMITTED ANYWHERE. UNDERSIDES OF COUNTERTOPS, INSIDE OF CABINETRY, AND WATER HEATER PLATFORMS MUST BE SEALED.

COOKLINE EQUIPMENT AND REACH-IN REFRIGERATION AND FREEZER UNITS
TO BE INSTALLED ON CASTERS. PROVIDE THE FOLLOWING: NSF STAINLESS

OR CABINETRY)

STEEL SHELF OVER 3-COMPTMENT SINK. HEAVY-DUTY MOP RACKS LOCATED OVER MOP SINK. HEAVY-DUTY BROOM RACKS IN JANITORIAL AREA. METAL GARBAGE CANS WITH LIDS FOR RESTROOMS. SANITARY BOX IN RESTROOM.

ALL NSF APPROVED HAND SINKS TO BE WITH BLADE HANDLED FAUCETS. BEVERAGE STATION & COUNTER TOP -STAINLESS STEEL.

ALL CABINET SHELVES -STAINLESS STEEL.
ALL CABINET BASE - 6" STAINLESS STEEL LEGS (NO KICK BASE)
LAVATORY COUNTERTOP TO BE SOLID SURFACE (NO PLASTIC LAMINATE

ANY PAINTED FINISHES TO BE SEMI-GLOSS OR GLOSS (NO FLAT, NO EGG SHELL, NO TEXTURE),

PROVIDE FRP ON WALL AND UNDERSIDE OF SERVICE AREA.
STAINLESS STEEL WALL FINISH FOR BEHIND AND ADJACENT TO COOK LINE.

FIRE EXTINGUISHERS TO BE TYPE K IN KITCHEN AND TYPE A IN DINING ROOM

FRP OR STAINLESS STEEL PANEL FOR KITCHEN WALL. KITCHEN CEILING FINISH TO BE PVC VINYL WASHABLE TILES.

- Dial stem thermometers (ranging from 0° to 220°F) are required in all preparation areas.
- Chemical test kits (specific to the sanitizer) are required for the appropriate sanitizer.
- pH meter and log for acidifying rice.
- All cooling/freezing units must have accurate thermometers.
- Covered waste cans are required in all restrooms.
- Toilets, urinals, hand sinks, 3 compartment sinks, mop sink, prep sinks, and permanent counters/cabinets must be sealed to floors and walls with a silicone caulk seal.
- Anti-siphon devices are required on all toilet tanks, urinals, and faucets with hose connections.
- Soap and paper towels are required at all hand sinks.
- Provide hair restraints and disposable gloves for all food handlers.
- If sinks are provided with spring-loaded faucets, the faucets must remain running for a minimum of 15 seconds

Doors leading to the outside and restroom doors are required to be self-closing and tight-fitting. Please confirm that the doors leading to the outside are equipped with a self-closer and weather strips to eliminate any air gaps.

ROOM FINISH SCHEDULE						
NO	ROOM	WALLS	BASE	FLOOR	CEILING	
100	CASHIER AREA	CERAMIC TILE	QT COVE BASE	FLOOR TILE	GYP BD PAINTED	
101	KITCHEN	STAINLESS STEEL	QT COVE BASE	QUARRY TILE	2'X4' VINYL TILE CEILING	
102	DINING AREA	GYP BD PAINTED	QT COVE BASE	FLOOR TILE	OPEN CEILING	
103	EXIST'G RESTROOM	CERAMIC TILE	QT COVE BASE	FLOOR TILE	2X2 ACOUSTIC TILE CEILING	
104	NEW RESTROOM	CERAMIC TILE	QT COVE BASE	FLOOR TILE	2X2 ACOUSTIC TILE CEILING	

DOOR SCHEDULE								
TAG	DESCRIPTION	FRAME CONSTRUCTION	NOMINAL SIZE W X H	DOOR FINISH	FRAME FINISH	LABEL	HARDWARE SET	COMMENTS
Α	STORE FRONT GLASS DOOR	ALUMINUM	3'-0" x 8'-0"	TEMPERED GLASS	ALUMINUM	-	2	EXIST'G FRONT EXIT DOOR
В	HOLLOW METAL DOOR	HOLLOW METAL	3'-0" x 7'-0"	PAINT	PAINT	-	2	EXIST'G BACK EXIT DOOR
С	WOOD DOOR	HOLLOW METAL	3'-0" x 6'-8"	PAINT	PAINT	-	1	NEW
* ALL EXIT DOORS MUST OPEN WITHOUT THE USE OF A KEY OR SPECIAL KNOWLEDGE FROM THE SIDE WHICH EGRESS IS MADE								
* LEVERED HANDLE HARDWARE AS REQUIRED BY ILLINOIS ACCESSIBILITY CODE								

	HARDWARE SCHEDULE
TAG	DESCRIPTION
1	1 1/2 PAIR BUTT HINGES, W/LEVERED PRIVACY LOCKSET , KICKPLATE AND DOOR CLOSER
2	1 1/2 PAIR BUTT HINGES, EXIT DEVICE AND DOOR CLOSER, PANIC HARDWARE
3	1 1/2 PAIR BUTT HINGES W/ PRIVACY LOCKSET

* PROVIDE DOOR CLOSERS ALONG ALL ACCESSIBLE ROUTES

ALL HARDWARE SHALL BE HEAVY-DUTY
COMMERCIAL GRADE AND ADA COMPLIANT,
CONTRACTOR TO VERIFY FINISH WITH OWNER.

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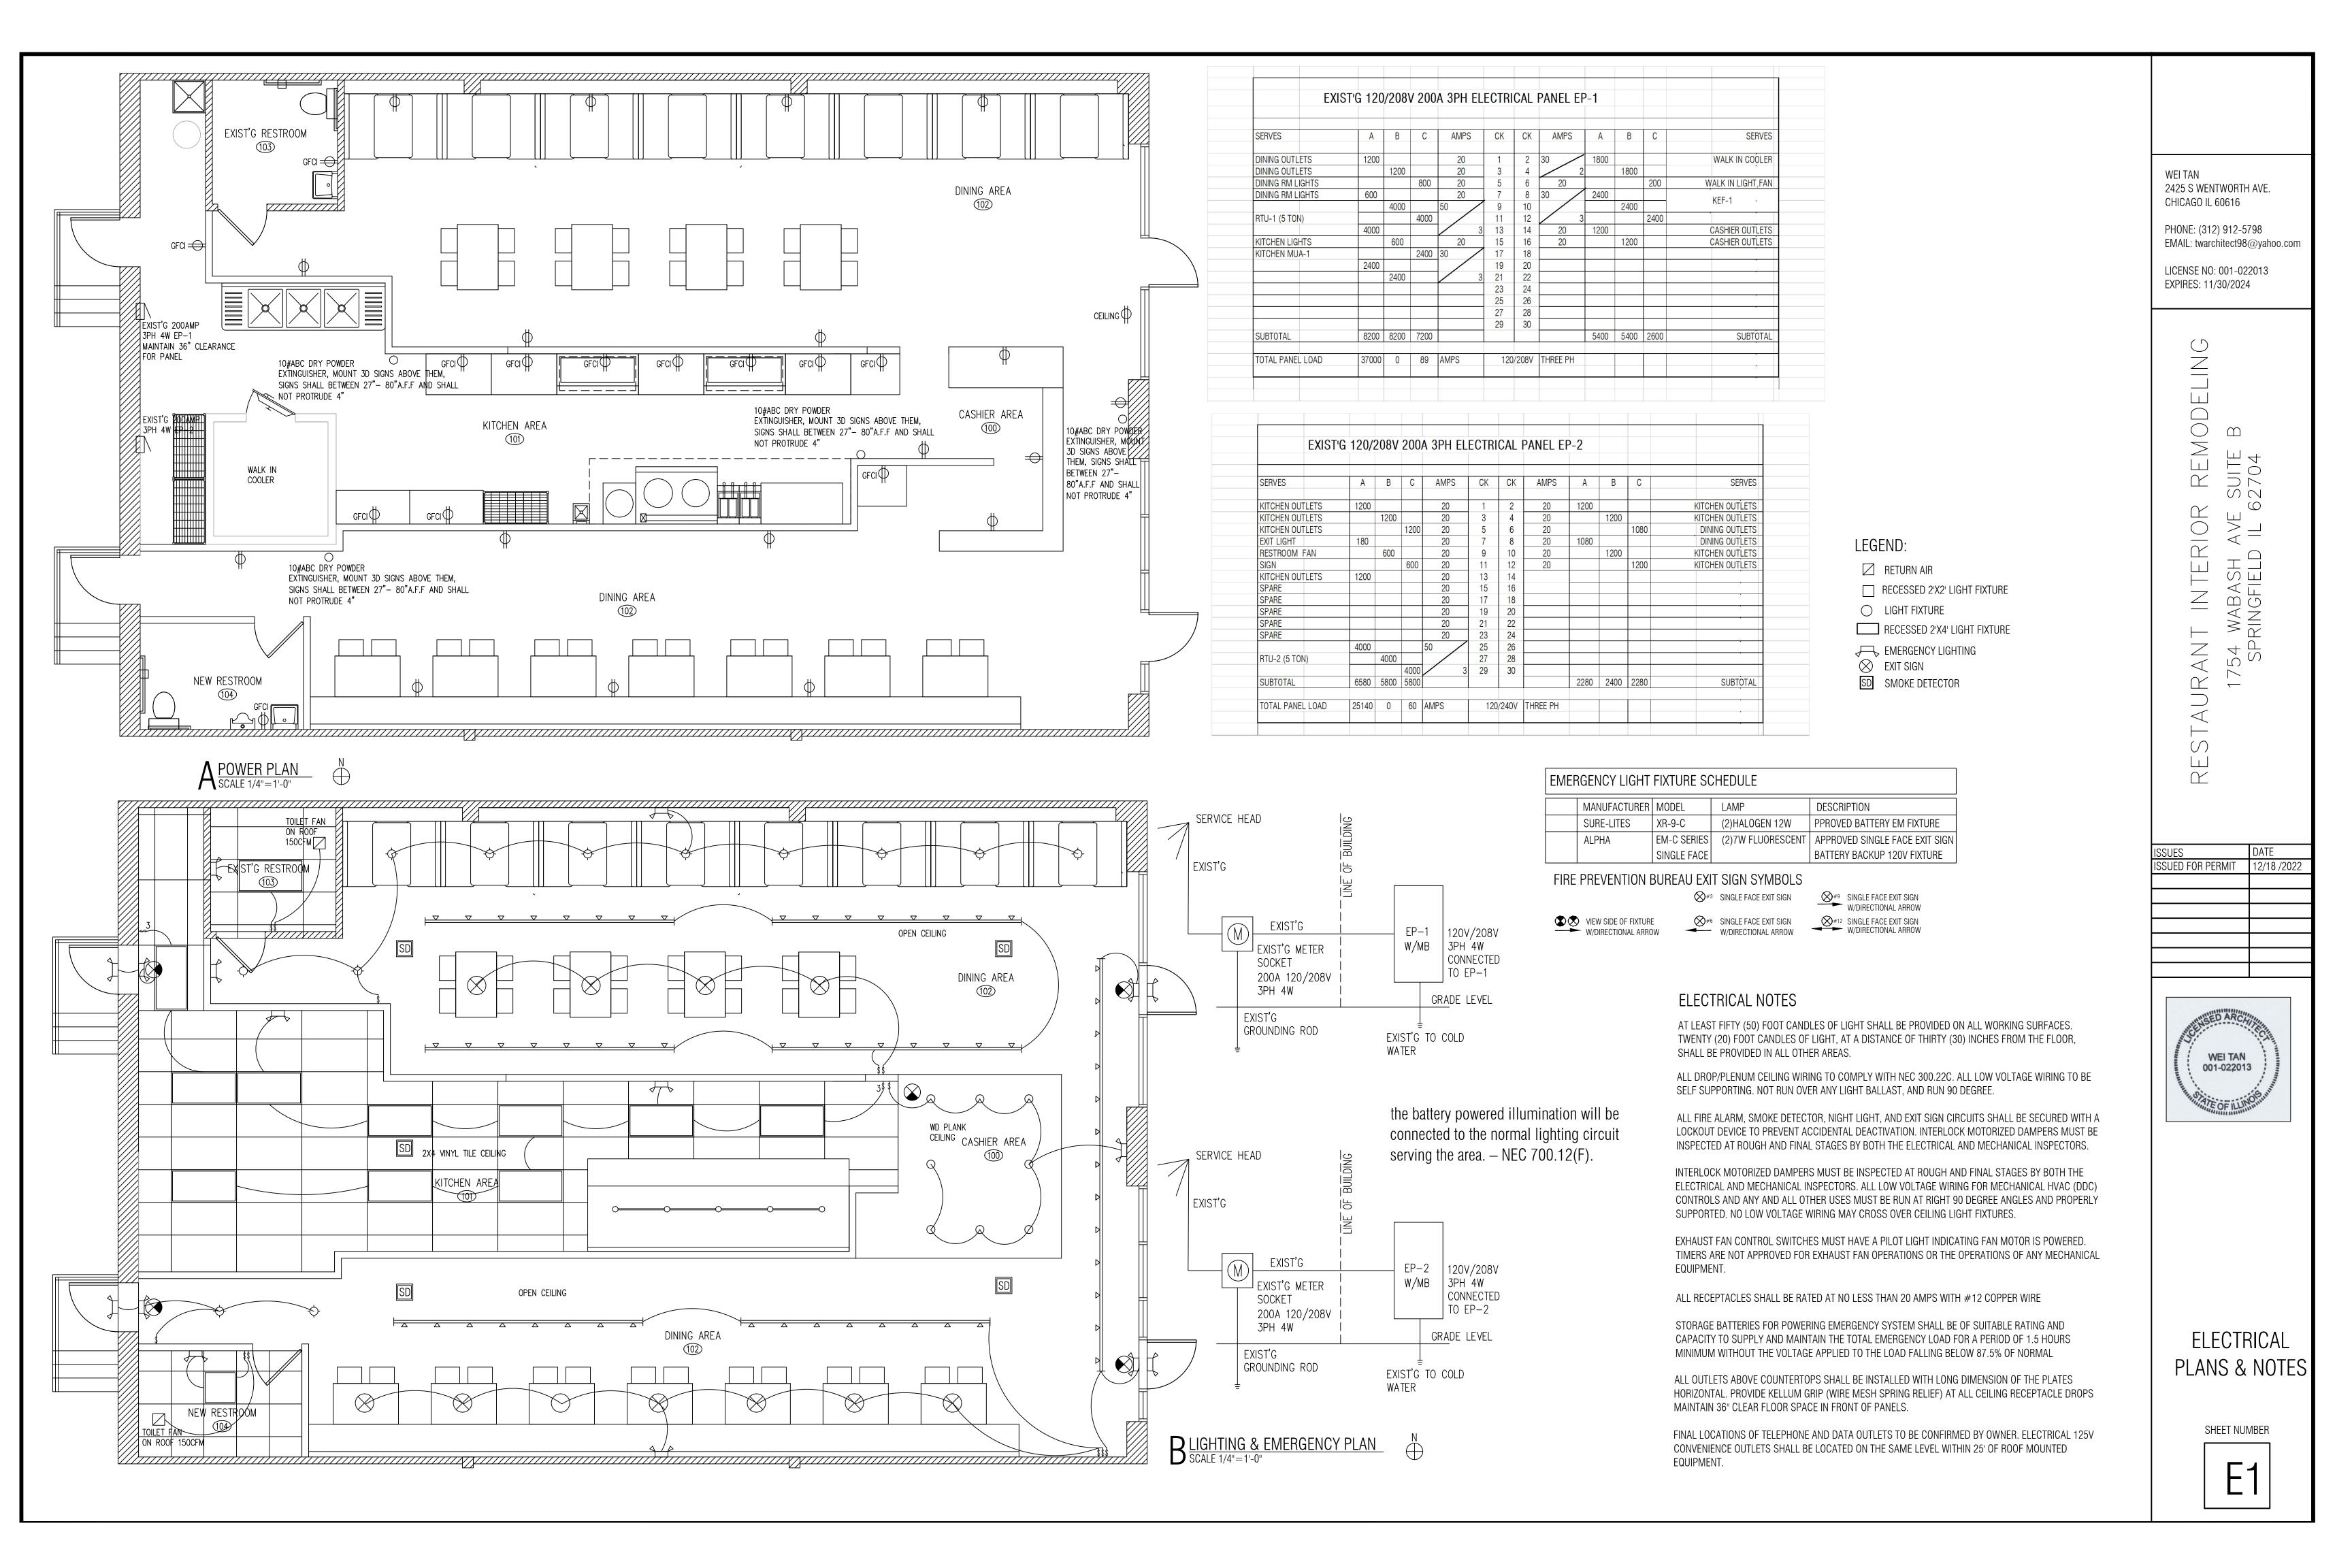
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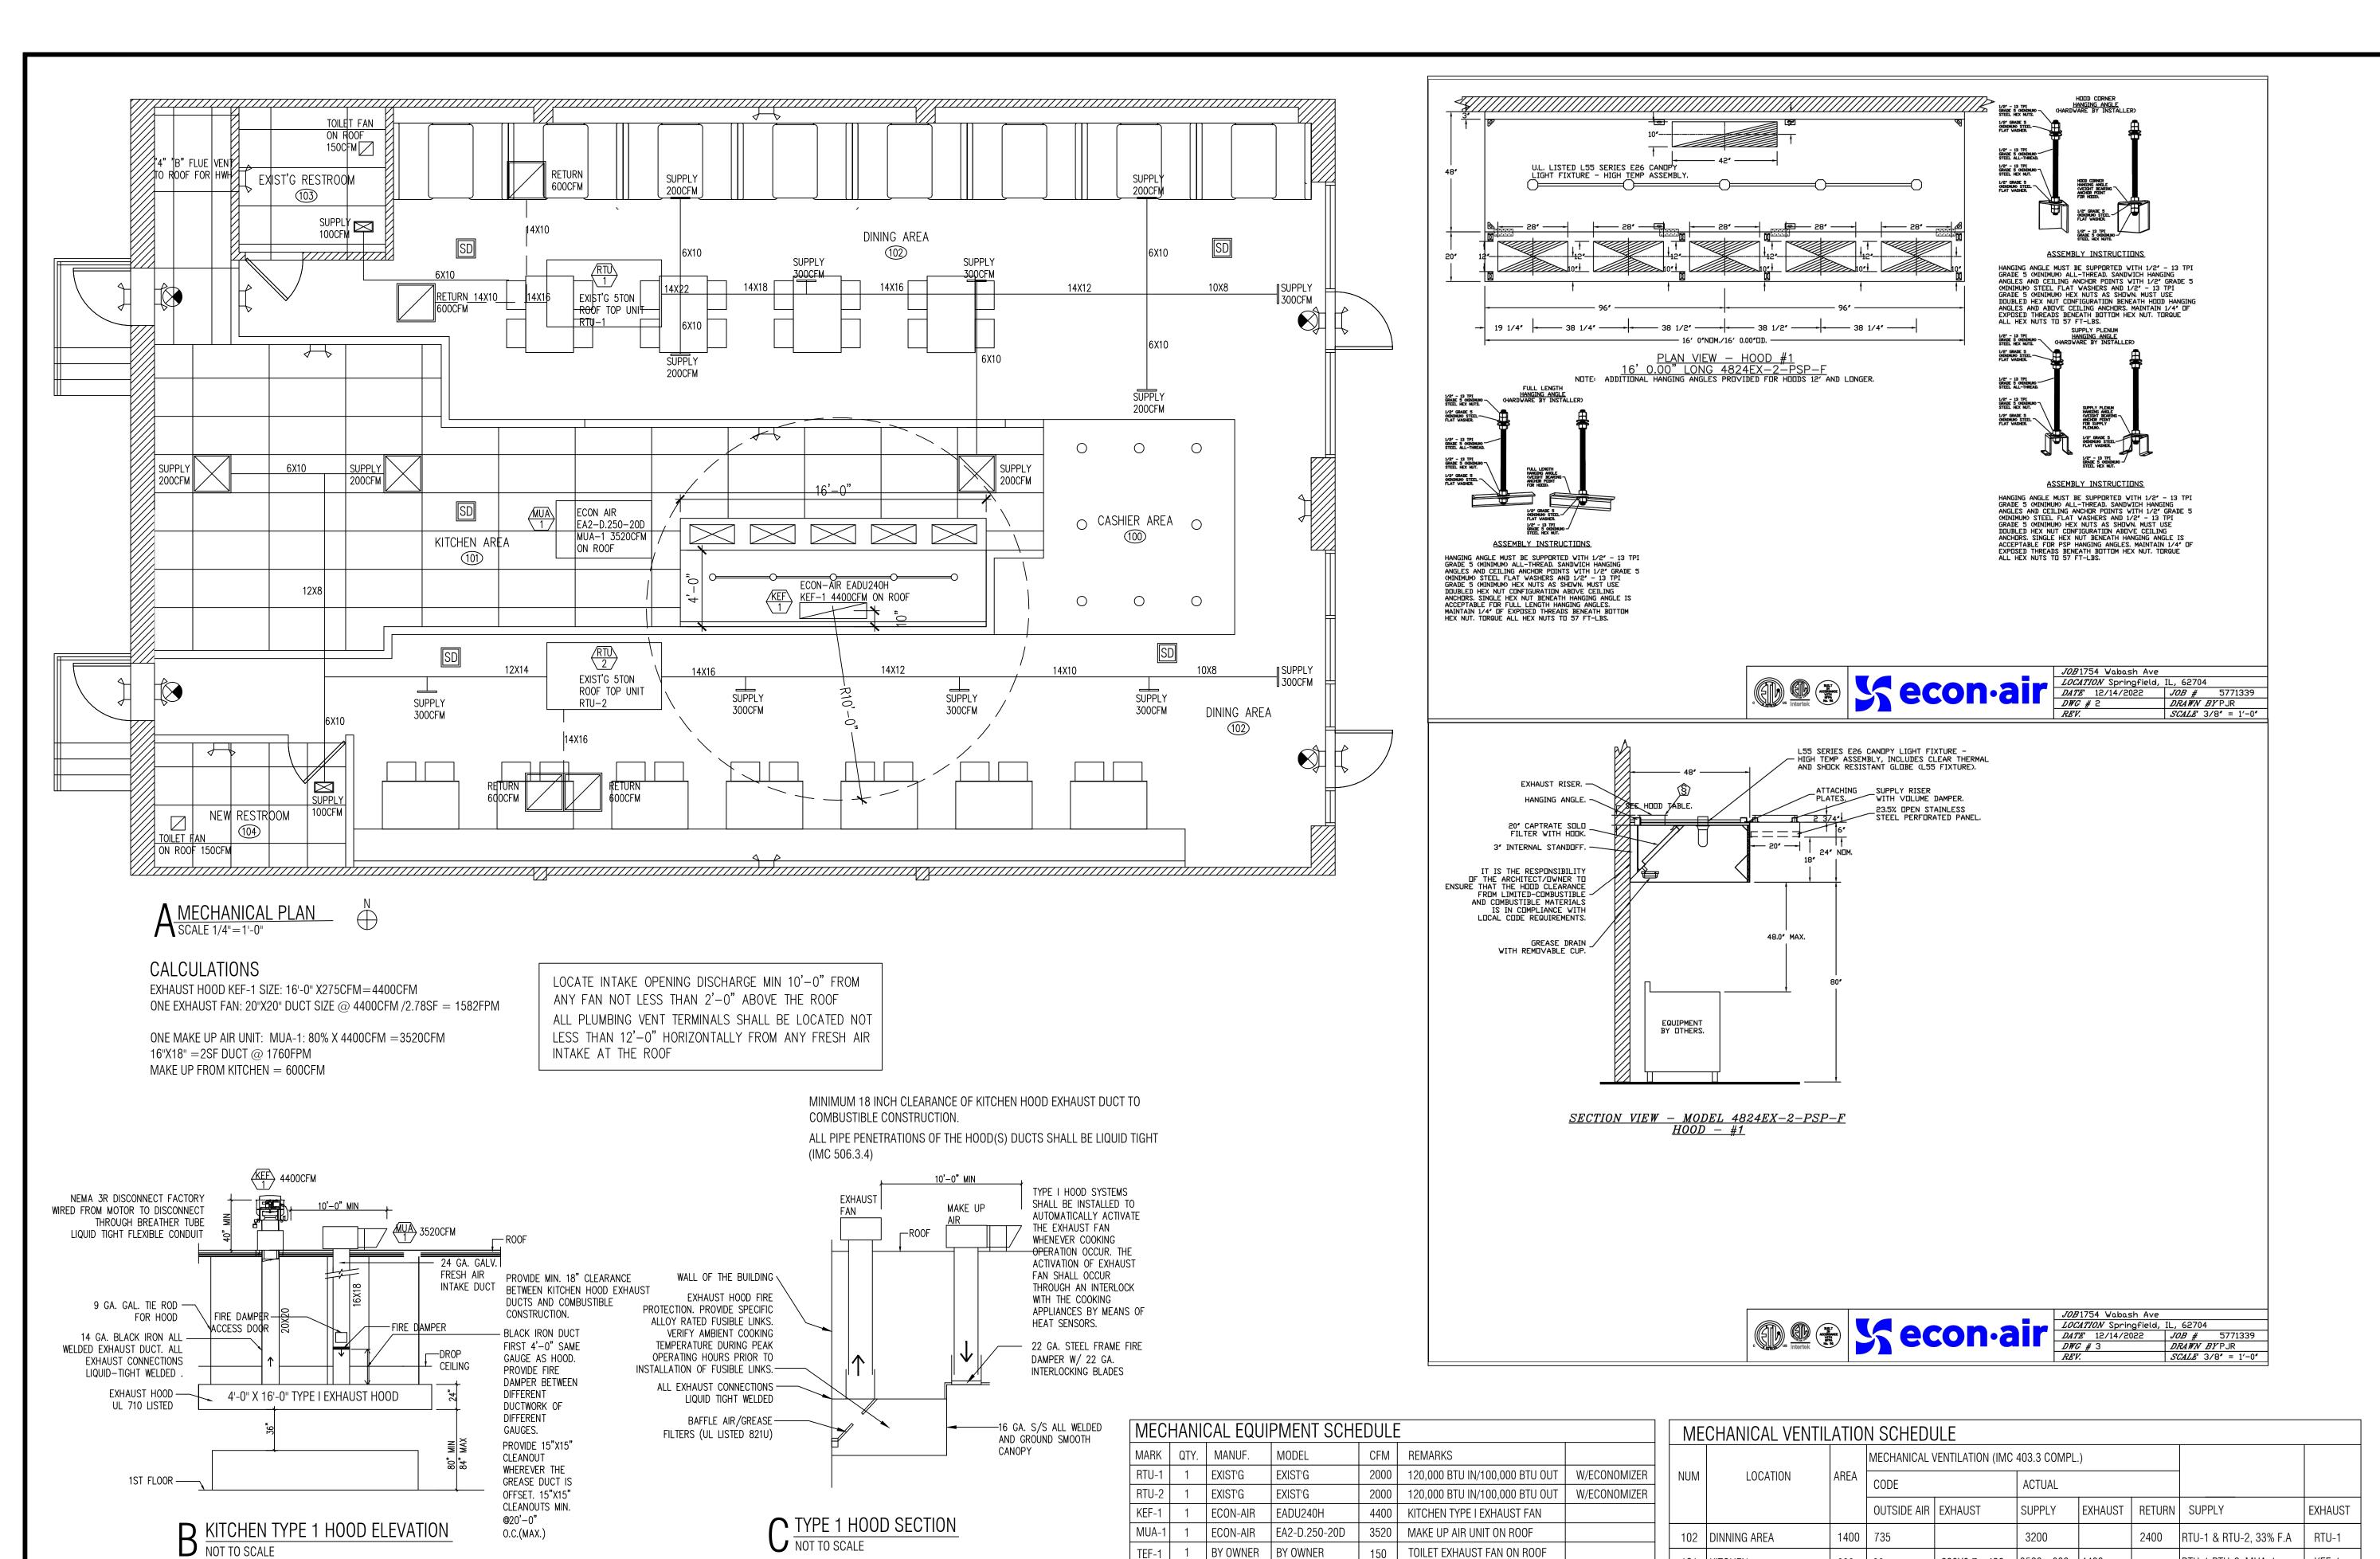
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FLOOR PLAN & NOTES







BY OWNER BY OWNER

150 TOILET EXHAUST FAN ON ROOF

TEF-2 | 1 | BY OWNER | BY OWNER

600 90

63 N.R

48

 $600X0.7 = 420 \quad | 3520 + 600 \quad | 4400$

100

100

4000 + 3520

150CFM

150CFM

RTU-1,RTU-2, MUA-1

2400

|PROVIDE 33%X4000CFM = 1320CFM FRESH AIR THRU. EXIST'G RTU-1 & RTU-2 ECONOMIZER

KEF-1

TEF-1

TEF-2

101 KITCHEN

103 EXIST'G RESTROOM

TTL SUPPLY (RTU-1, RTU-2 AND MUA-1)

104 NEW RESTROOM

TTL EXHAUST (KEF-1)

TOTAL RETURN AIR

TOTAL OUTDOOR AIR

SHEET NUMBER

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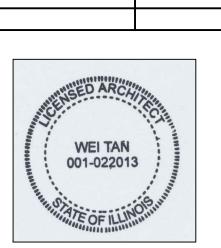
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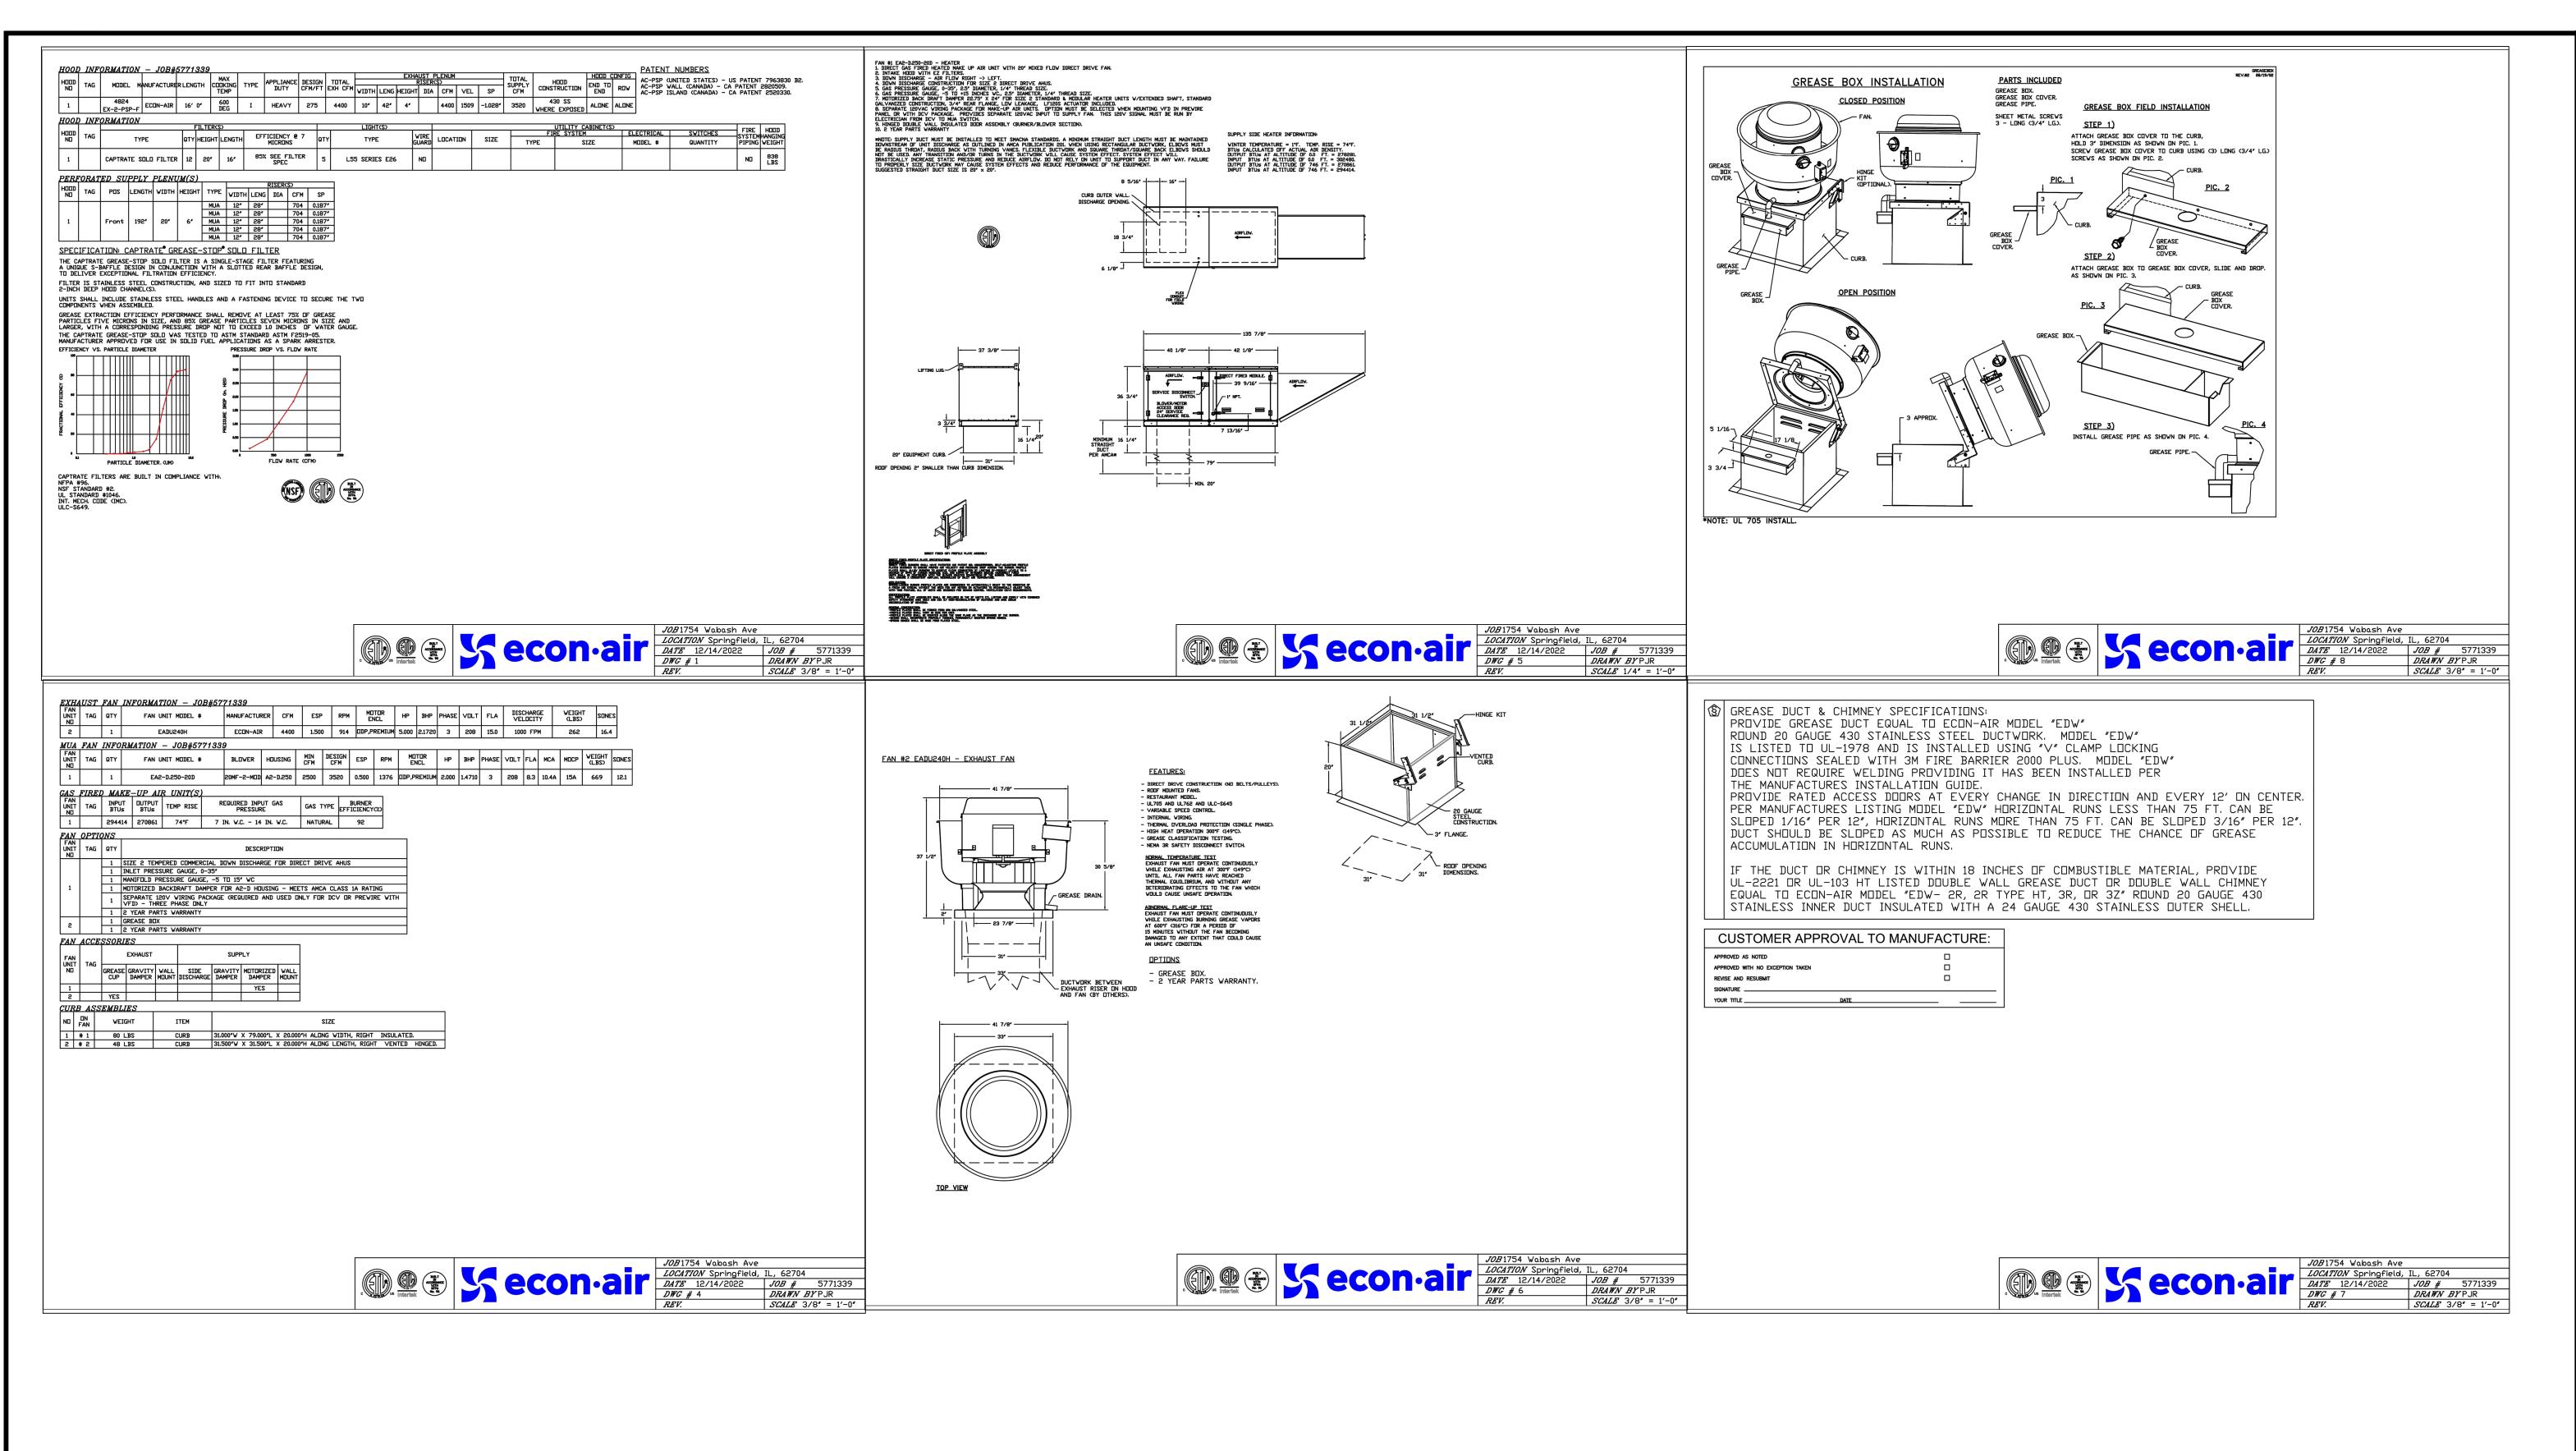
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MECHANICAL PLAN & **SCHEDULES**



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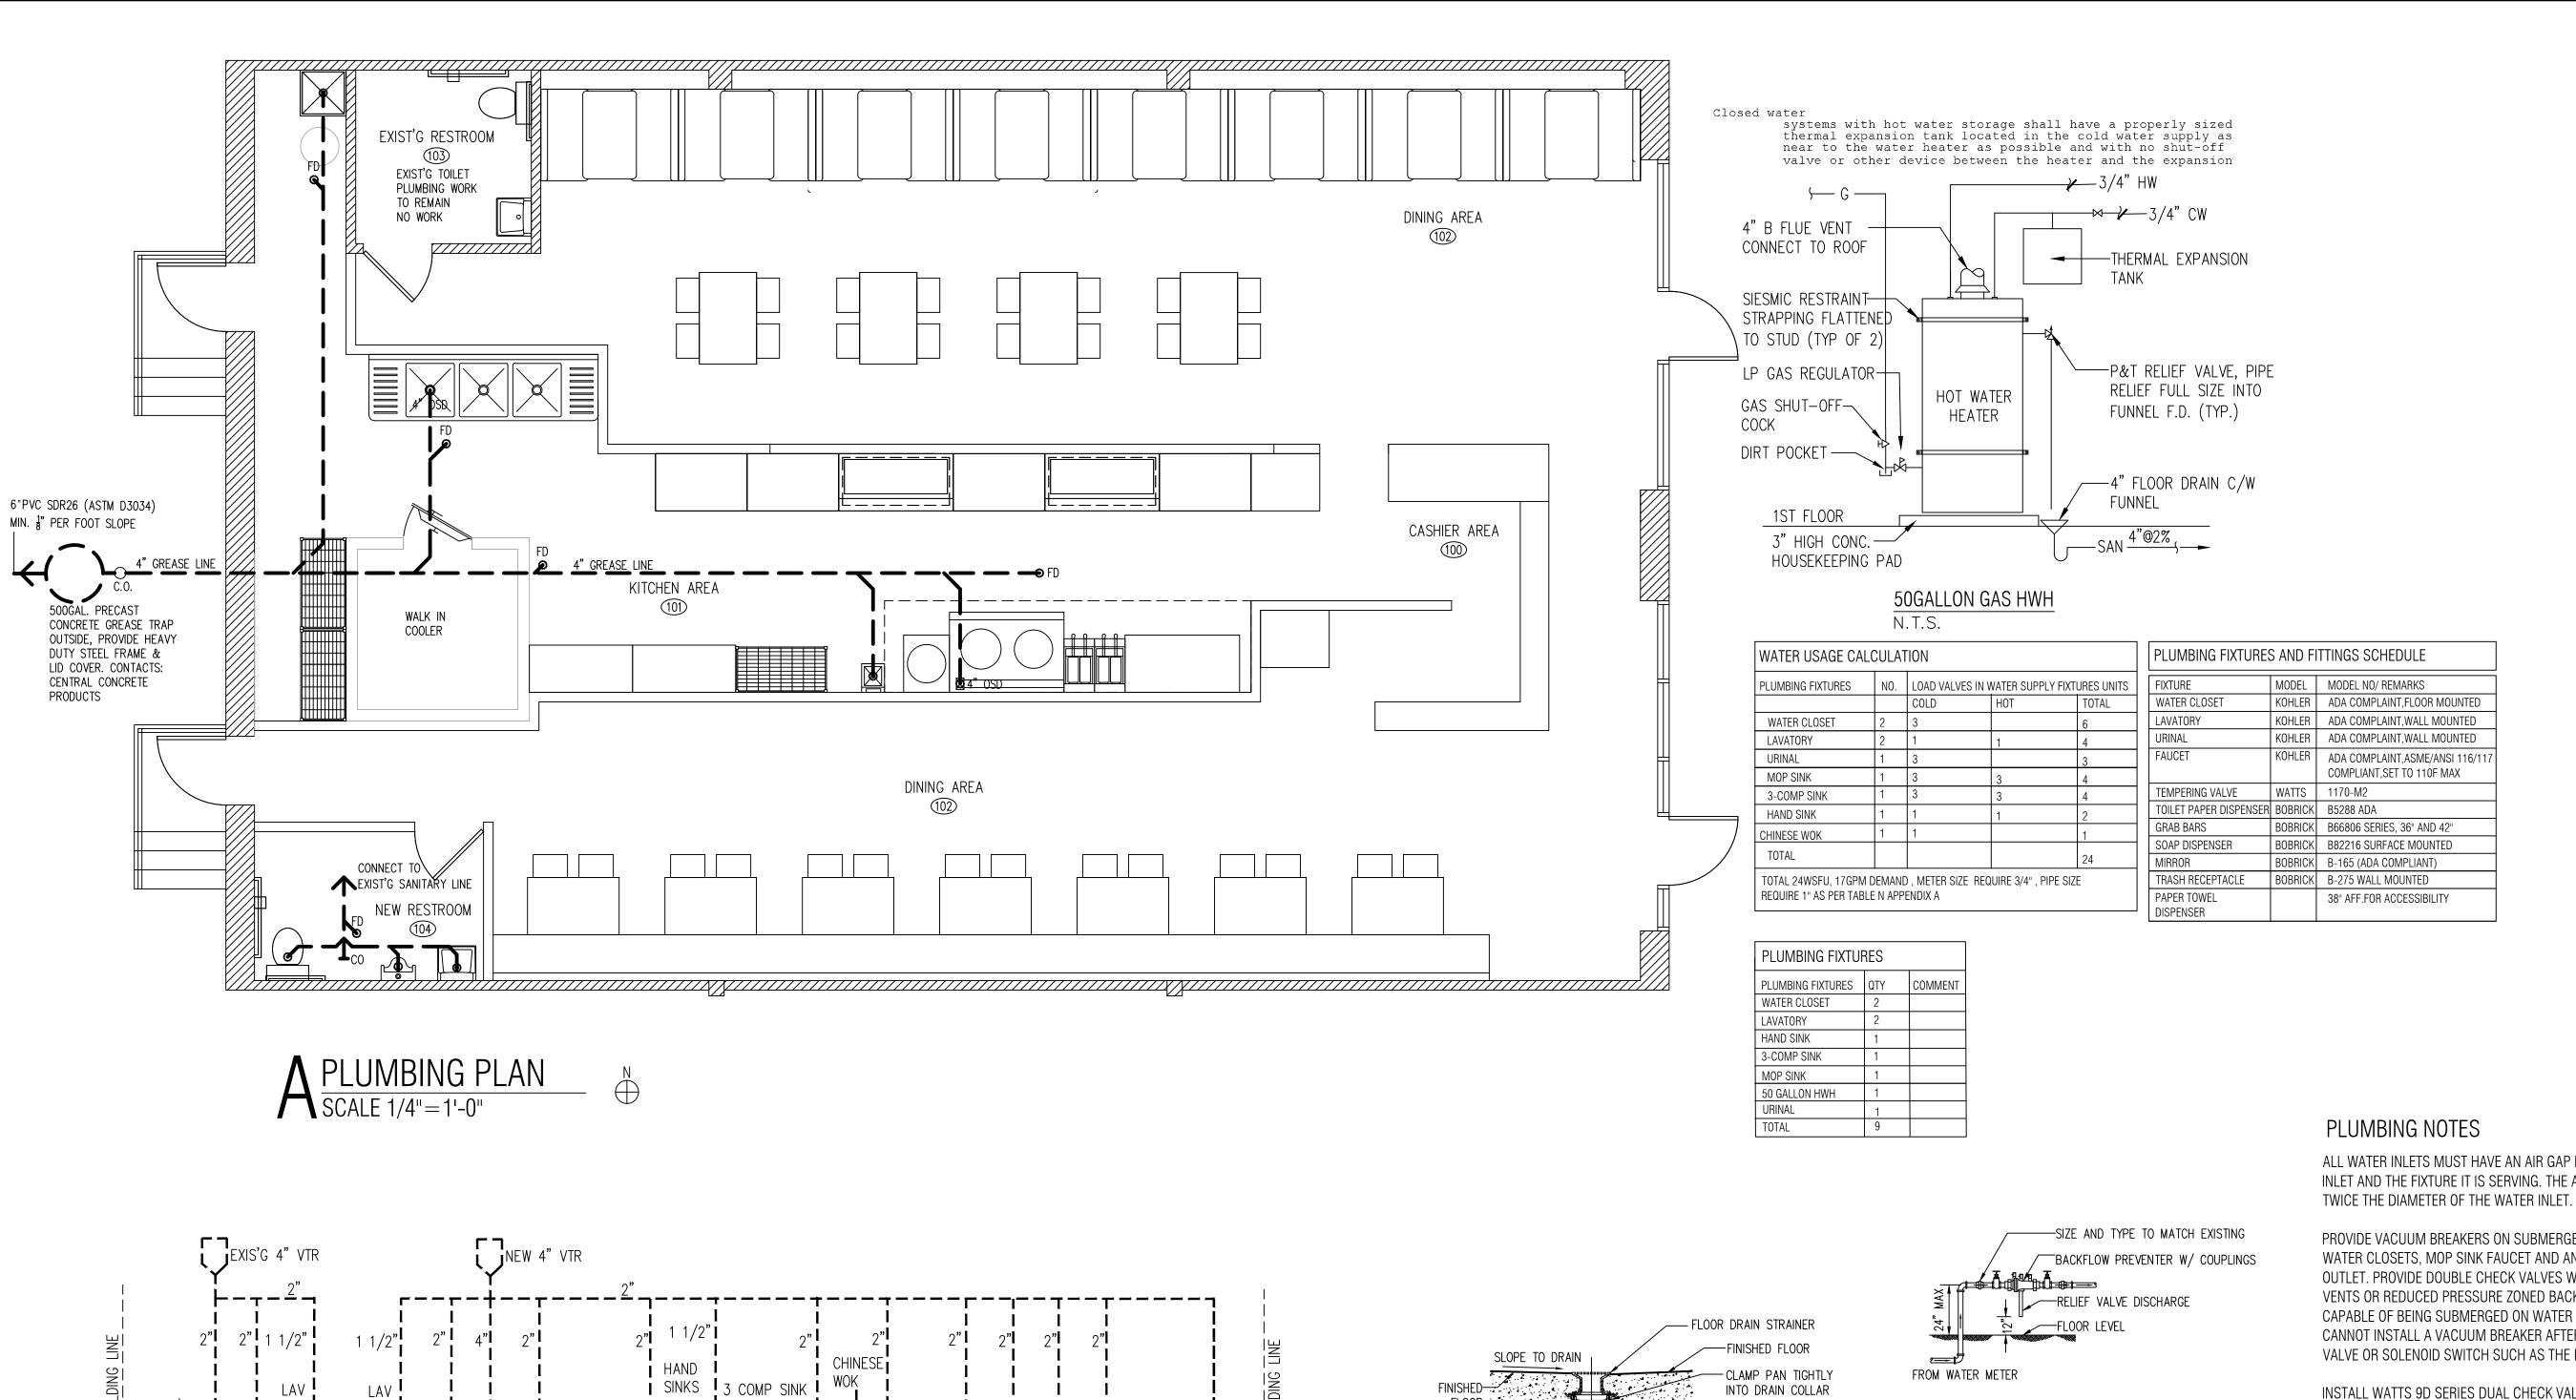
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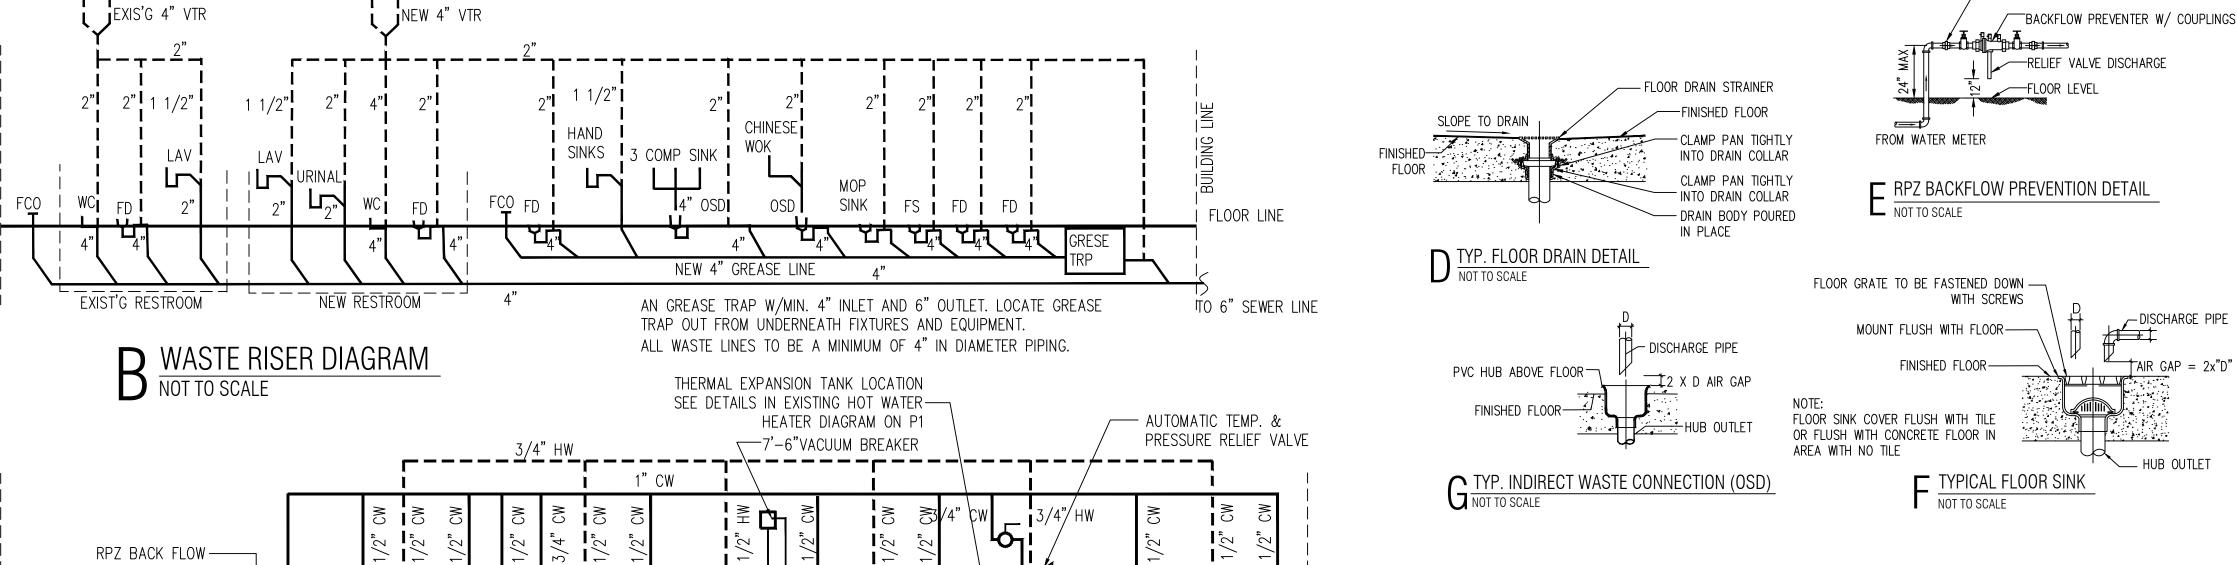
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HOOD DETAILS







DRAIN

WOK

WATER HEATER

W/WATER PAN

50GAL HWH

SINK

3 COMP

HAND

SINK

im m

EXIST'G MOP SINK

WC UR LAV

G RFSTROOM NEW RESTROOM

EXIST'G RESTROOM

SUPPLY RISER DIAGRAM

NOT TO SCALE

PROTECTION

3/4" COLD

FLOOR LINE

WATER METER

ALL WATER INLETS MUST HAVE AN AIR GAP BETWEEN THE WATER INLET AND THE FIXTURE IT IS SERVING. THE AIR GAP MUST BE

PROVIDE VACUUM BREAKERS ON SUBMERGED INLETS SUCH AS WATER CLOSETS, MOP SINK FAUCET AND ANY THREADED WATER OUTLET. PROVIDE DOUBLE CHECK VALVES WITH ATMOSPHERIC VENTS OR REDUCED PRESSURE ZONED BACKFLOW PREVENTERS CAPABLE OF BEING SUBMERGED ON WATER INLETS WHERE YOU CANNOT INSTALL A VACUUM BREAKER AFTER THE LAST SHUT OFF VALVE OR SOLENOID SWITCH SUCH AS THE PRE-WASH SPRAYER.

INSTALL WATTS 9D SERIES DUAL CHECK VALVE WITH INTERMEDIATE ATMOSPHERIC VENT BACKFLOW PREVENTOR

TO PREVENT BACKFLOW FROM CHEMICAL SYSTEM AT 3 COMP SINK, PROVIDE AN ECO-LAB PATHWAYS ELECTRONIC UNIT OR EQUIVALENT. THERE SHALL BE NO DRILLING OR TAPPING OF ANY PORTABLE WATER SUPPLY PIPE, FITTING OR FIXTURE FITTING FOR THE PURPOSE OF INTRODUCING SUCH CHEMICALS.

INDIRECT WASTE DRAINS ARE REQUIRED AT ALL THREE COMPARTMENT SINKS, WALK-IN COOLERS/FREEZERS CONDENSATE, OR ANY FOOD RELATED EQUIPMENT REQUIRING DRAINAGE.

PROVIDE ALL LABOR, MATERIALS, REQUIRED PERMITS, INSPECTION FEE NECESSARY FOR AND INCIDENTAL TO THE INSTALLATION OF COMPLETE PLUMBING SYSTEM INCLUDING ALL PIPES FITTINGS EQUIPMENTS AND NECESSARY APPURTENANCE.

ALL PLUMBING INSTALLATIONS SHALL MEET STATE OF ILLINOIS, HEALTH DEPARTMENT REQUIREMENTS.

SIZE AND LOCATION OF GREASE TRAP SHALL MEET LOCAL CODE REQUIREMENT. OBTAIN AND PAY FOR PERMITS AND FEES FROM LOCAL SANITARY DISTRICT HAVING JURISDICTION.

ALL ABOVE GROUND SUPPLY WATER PIPING SHALL BE COPPER TYPE L. ABOVE GROUND WASTE / VENT PIPING SHALL CONFORM. TO 2014 ILLINOIS PLUMBING CODE. UNDERGROUND WASTE & VENT PIPING SHALL CONFORM TO 2014 ILLINOIS PLUMBING CODE SEWER AND WASTE PIPING SHALL BE PRESSURE TESTED PER LOCAL PLUMBING CODE.

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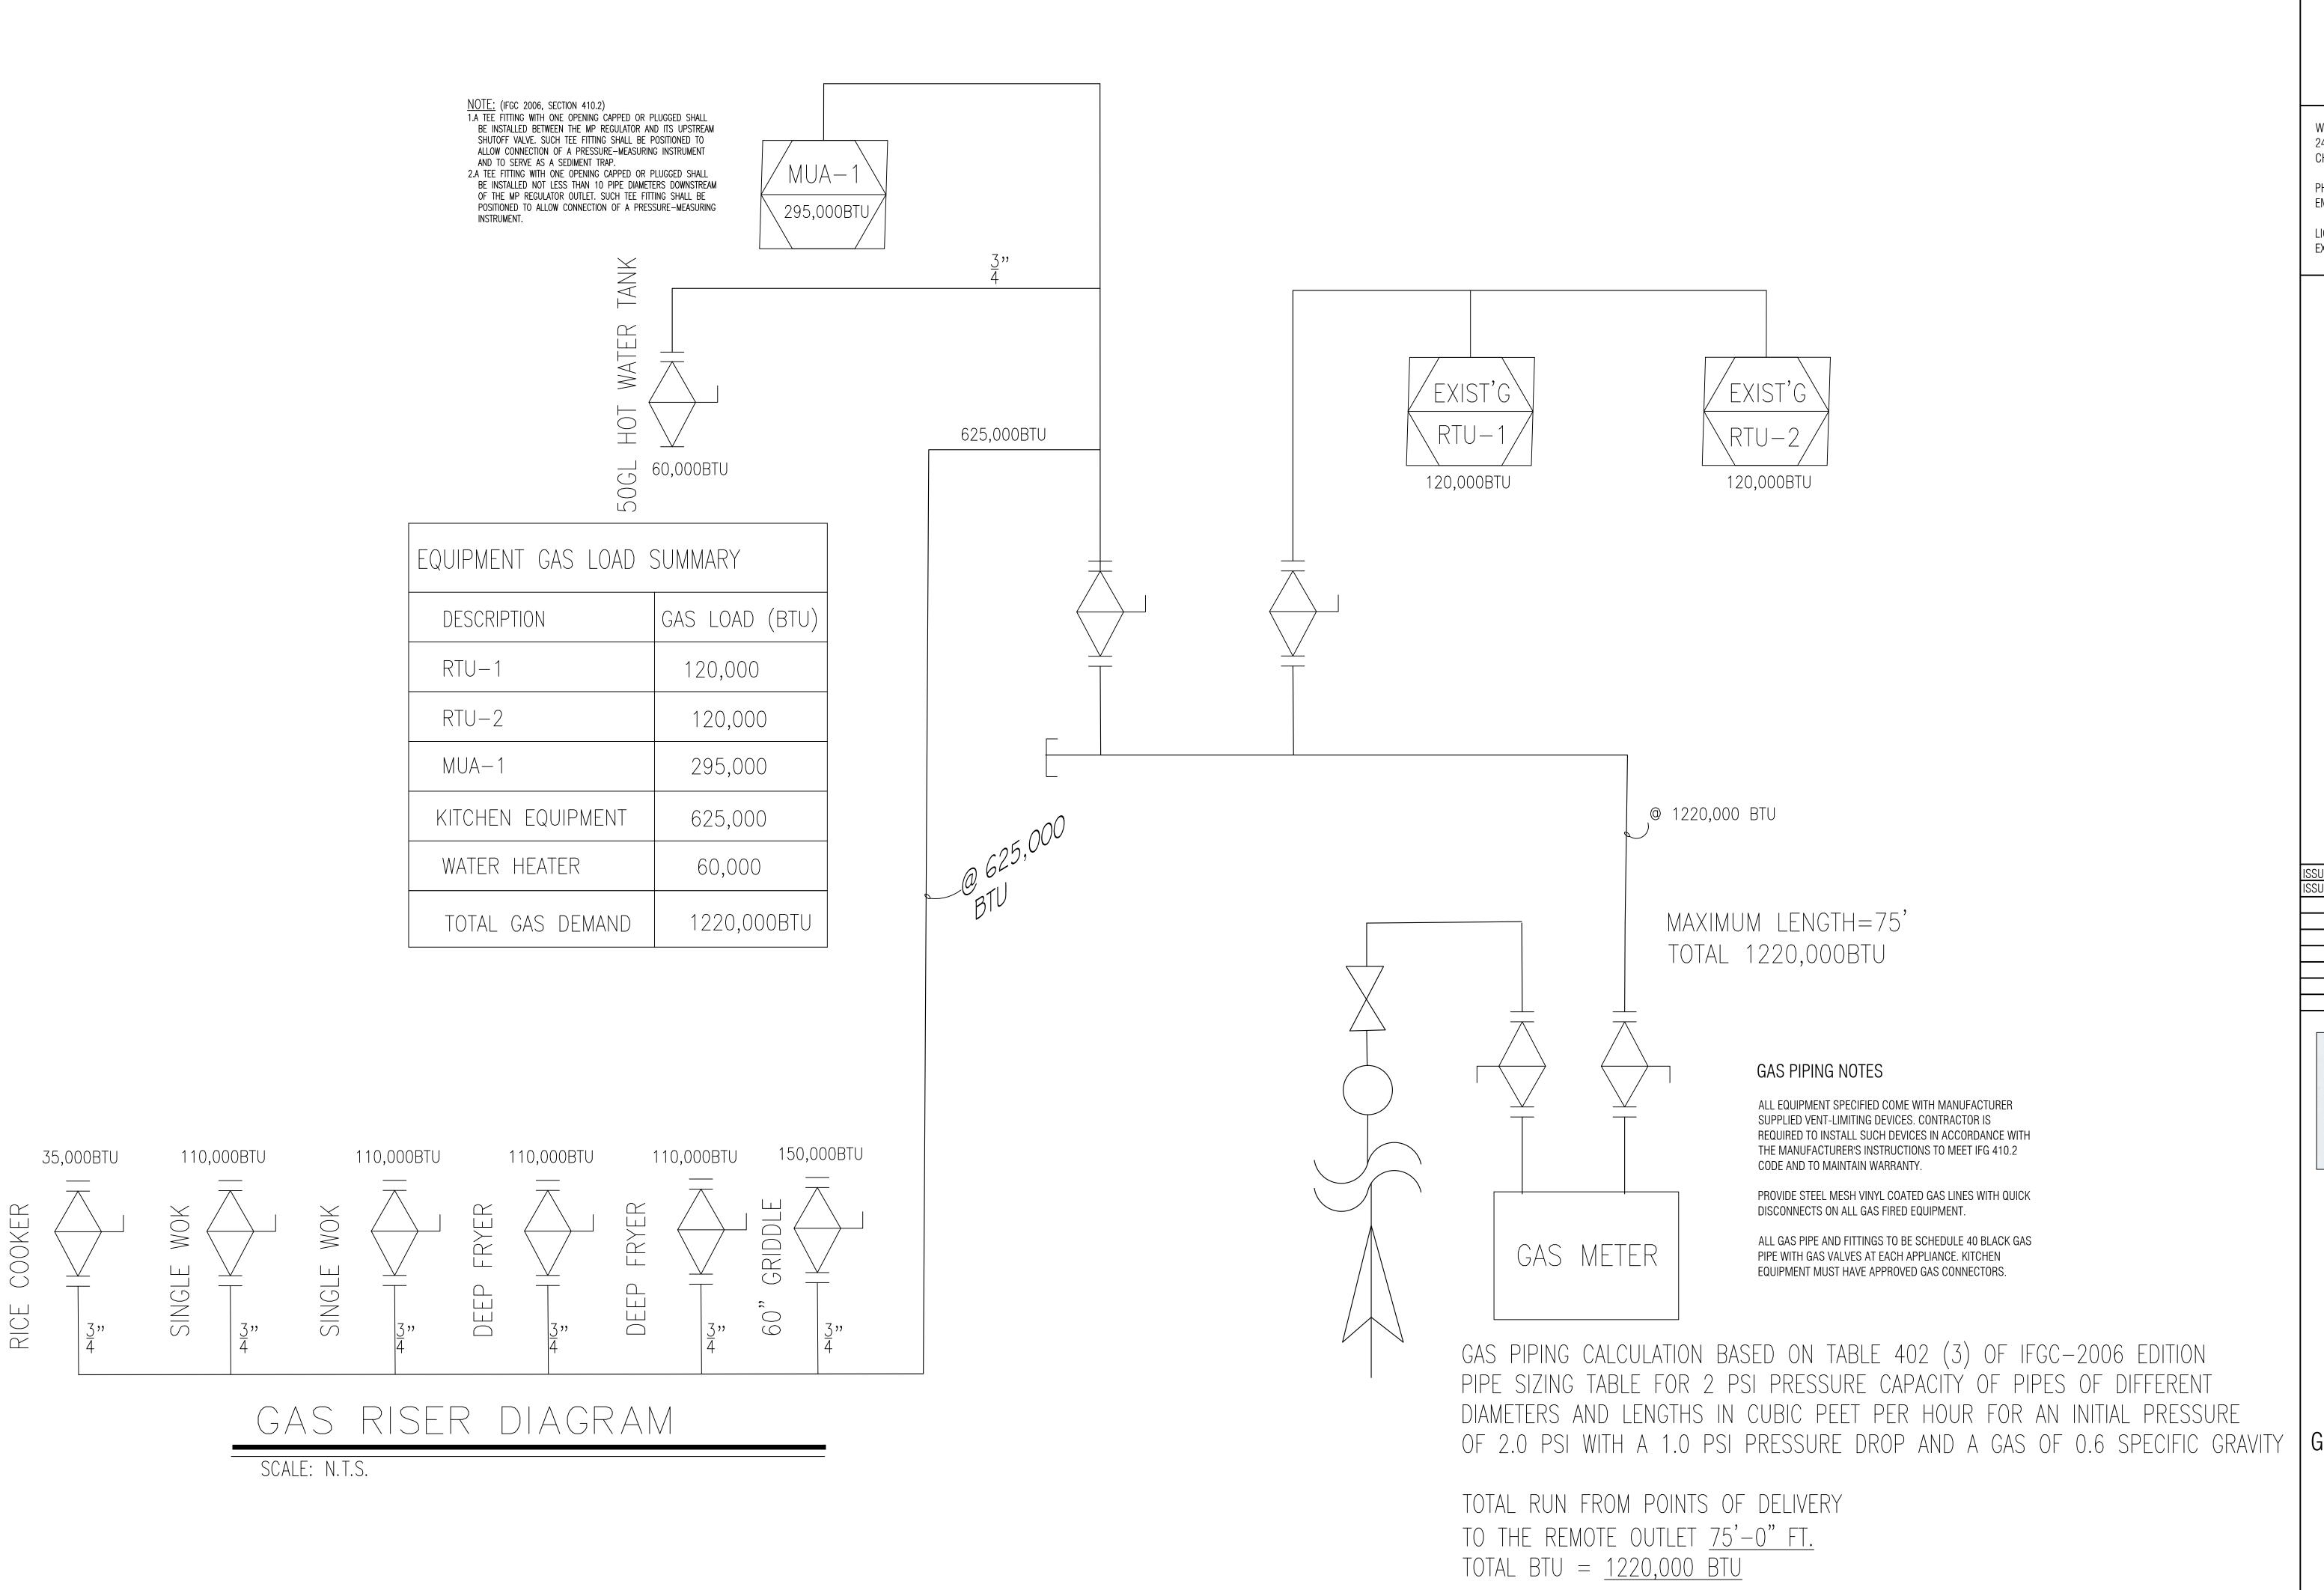
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PLUMBING PLAN & NOTES





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GAS PIPING PLAN & NOTES

