### **GENERAL PROJECT NOTES**

#### SUMMARY OF WORK

INTERIOR ALTERATION OF EXISTING 4088SF WAREHOUSE TO A NEW OFFICE. PROVIDE ALL NECESSARY ARCHITECTURAL, ELECTRICAL & HVAC & PLUMBING WORK.

#### **GENERAL INSTRUCTIONS**

THESE DRAWINGS ARE SCOPE DOCUMENTS INDICATING THE GENERAL PROJECT DESIGN CONCEPT, DIMENSIONS OF THE PROJECT, MAJOR ARCHITECTURAL ELEMENTS, AND BASIC ORGANIZATION OF MECHANICAL, ELECTRICAL AND PLUMBING SYSTEMS. AS SCOPE INDICATE ALL MATERIALS OR WORK REQUIRED FOR FULL COMPLETION OF THIS PROJECT. FURTHER MORE THE ARCHITECT MAKES NO WARRANTY EXPRESSED OR IMPLIED ON THESE DOCUMENTS

DUE TO THE NATURE OF THIS WORK THE ARCHITECT DOES NOT DISCREPANCIES TO THE ARCHITECT, OWNER, OR THE OWNER'S

CONTRACTOR SHALL OBTAIN AND PAY FOR ANY PERMITS AND FEES REQUIRED TO PERFORM THE WORK, UNLESS DIRECTED OTHERWISE BY

EACH CONTRACTOR SHALL BE RESPONSIBLE FOR STORAGE AND THE SITE TO AVOID OVERLOADING OF EXISTING FLOOR

CONTRACTORS INSTALLING PIPES, DUCTS AND CONDUIT WILL BE REQUIRED TO DO ALL CUTTING AND PATCHING IN CONNECTION WITH THEIR WORK, INCLUDING EXCAVATION AND DIGGING. THE OWNER WILI ASSUME NO RESPONSIBILITY FOR THE COST OF CHANGES OR EXTRA WORK MADE NECESSARY BY THE FAILURE OF TRADES TO COORDINATE THEIR WORK DURING CONSTRUCTION.

WHERE APPLICABLE THE GC SHALL CONSTRUCT PHYSICAL BARRIERS AROUND AREAS UNDER CONSTRUCTION AS REQUIRED TO ENSURE GENERAL PUBLIC AND PERSONAL SAFETY.

THE GC SHALL SUPERVISE AND DIRECT THE WORK, HE SHALL BE SOLELY RESPONSIBLE FOR ALL CONSTRUCTION MEANS, METHODS, TECHNIQUES, SEQUENCES AND PROCEDURES. THE GC SHALL BE RESPONSIBLE FOR COORDINATING ALL PORTIONS OF THE WORK UNDER HIS CONTRACT. ALL WORK SHALL BE COMPLETED USING PRACTICES ACCEPTED AND ENDORSED BY THE CORRESPONDING TRADE INDUSTRIES.

THE TERM "PROVIDE" SHALL MEAN TO FURNISH AND INSTALL.

THE CONTRACT AND SUBCONTRACT AMOUNTS SHALL PROVIDE COMPLETE WORKING MECHANICAL, ELECTRICAL AND PLUMBING SYSTEMS COMMENSURATE WITH THE REQUIREMENTS OF THE CONTRACT DOCUMENTS AND THE APPLICABLE CODES.

WHEN WALLS ARE TO BE "ALIGNED", THE ALIGNMENT OF SUCH WALLS IS TO THE OUTSIDE FINISHED SURFACE, SUCH AS DRYWALL SURFACE.


ALL DIMENSIONS SHOWN ARE TO FINISH FACE OF WALL UNLESS NOTED OTHERWISE. DIMENSIONS AND NOTES FOR A GIVEN CONDITION ARE TYPICAL FOR ALL SIMILAR CONDITIONS UNLESS NOTED OTHERWISE.

WHERE NEW WORK ADJOINS EXISTING, ALL SUCH NEW WORK SHALL BE PROPERLY INTERGRATED WITH THE EXISTING TO ENSURE UNIFORM APPEARANCE. ANY REPAIR WORK REQUIRED TO EXISTING WORK SHOULD BE TAKEN CARE OF BY THE CONTRACTOR - PROVIDING ALL NECESSARY CUTTING, FITTING AND PATCHING AND SHALL FURNISH ALL NECESSARY LABOR AND MATERIALS FOR THIS WORK. ALL WORK REQUIRING SPECIAL DETAILING, AND NOT DETAILED ON THE DRAWINGS SHOULD BE BROUGHT TO THE ATTENTION OF THE ARCHITECT / OWNER.


THE GENERAL CONTRACTOR SHALL COORDINATE ALL TRADES TO AVOID INTERFERENCE, TO PRESERVE MAXIMUM HEADROOM, AND AVOID OMISSIONS.


THE ARCHITECT HAS NO CONTRACTUAL DUTY TO CONTROL MEANS AND METHODS OF THE WORK NOR TO PROVIDE JOB SITE SUPERVISION. ENSURE SAFETY OR CONSTRUCTION MANAGEMENT AND DOES NOT VOLUNTARILY ASSUME ANY SUCH RESPONSIBILITIES.


# INTERIOR BUILD-OUT A NEW OFFICE IN THE EXISTING WAREHOUSE PERMIT SUBMITTAL 2700 GALVIN DRIVE ELGIN IL 60124

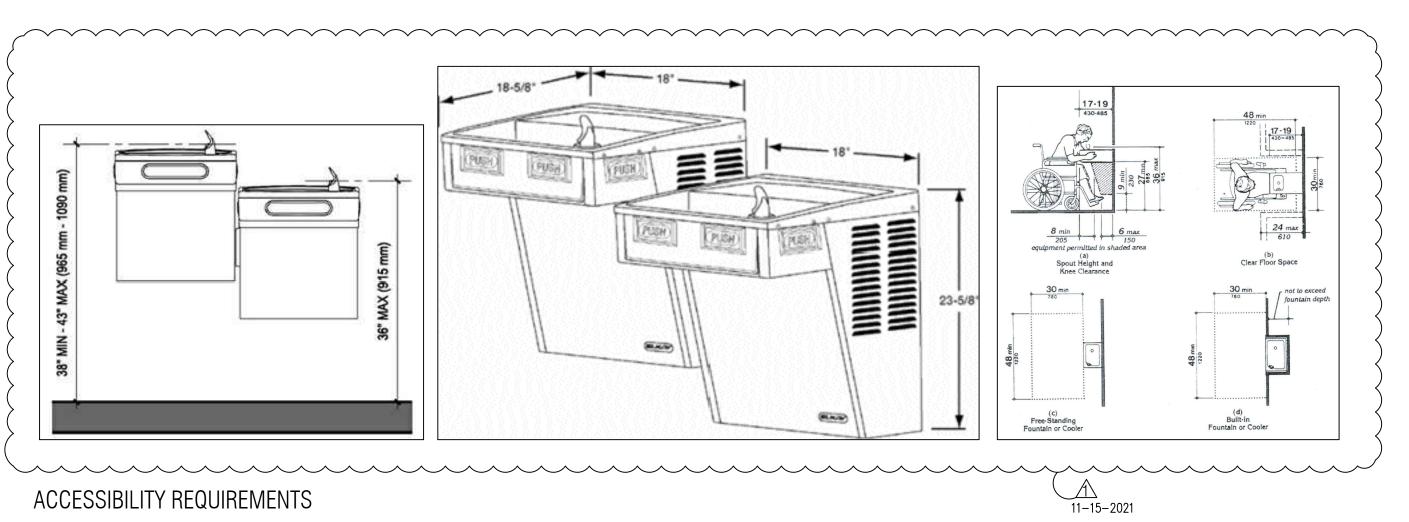

ACT WHICH INCLUDES, BUT IS NOT LIMITED TO THE FOLLOWING:

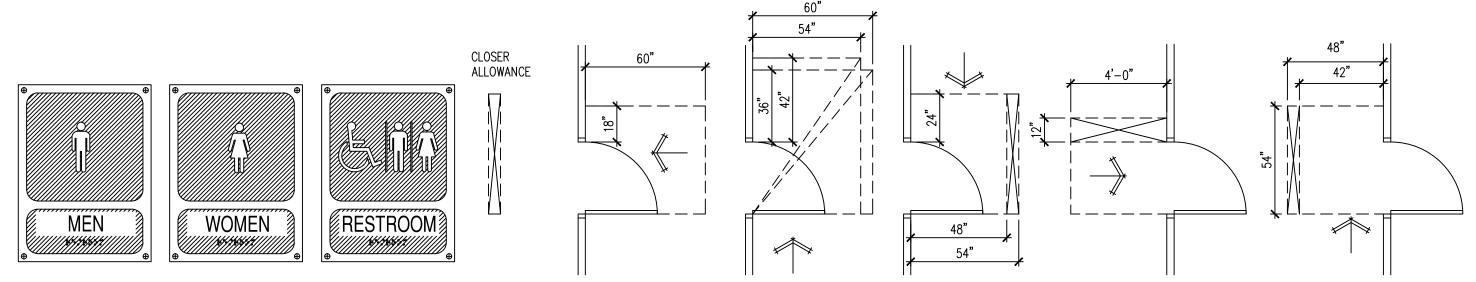

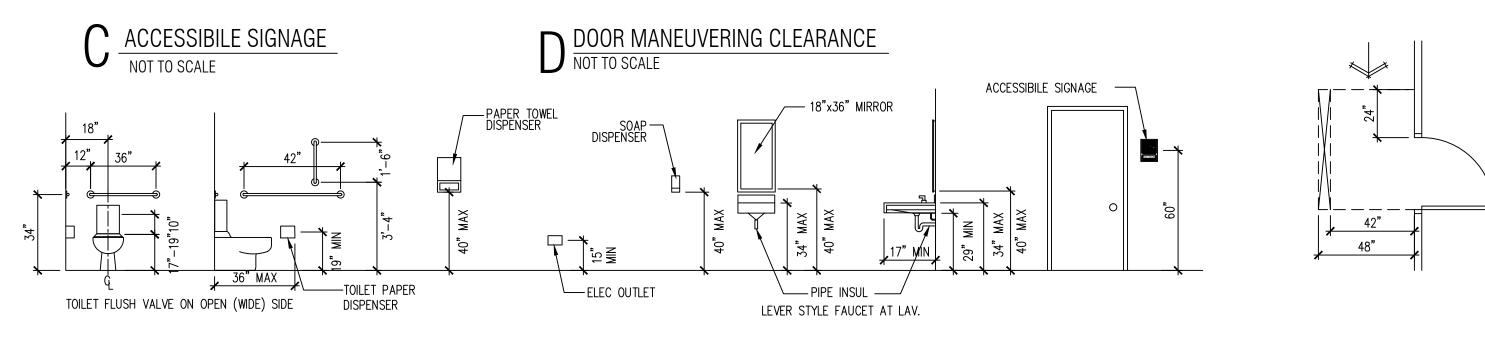

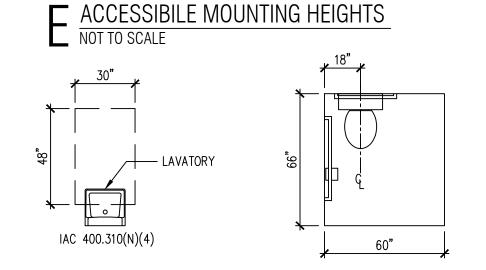

**D** TYPICAL ACCESSIBILITY REQUIREMENTS



5'-0" TURNING RADIUS

- EXIST'G WAREHOUSE FLOOR PLAN OCCUPANCY & EXITING DIAGRAM, OFFICE REFLECTED CEILING PLAN
- NEW OFFICE FLOOR PLAN & SCHEDULES SERVICE DIAGRAM OFFICE ELECTRICAL PLANS & NOTES
- PLUMBING PLAN & NOTES
- OFFICE MECHANICAL PLAN & NOTES



# $A = \frac{\text{SITE PLAN}}{\text{NOT TO SCALE}} \stackrel{\text{N}}{\oplus}$

CODE DATA ALL CONSTRUCTION SHALL BE IN ACCORDANCE WITH ALL APPLICAE FEDERAL, STATE AND MUNICIPAL LAWS, ORDINANCES, STANDARDS REGULATORY AGENCIES INCLUDING BUT NOT LIMITED TO THE

11-15-2021


2015 INTERNATIONAL BUILDING CODE W/ LOCAL AMENDMENTS 2015 INTERNATIONAL MECHANICAL CODE W/ ELGIN AMENDMENTS 2018 INTERNATIONAL ENERGY CONSERVATION CODE 2014 NATIONAL ELECTRIC CODE W/ELGIN AMENDMENTS

REQUIREMENTS (INCLUDING LOCAL AMENDMENTS) OF

2014 STATE OF ILLINOIS PLUMBING CODE 2015 INTERNATIONAL FIRE CODE 2015 NATIONAL FUEL GAS CODE NFPA LIFE SAFETY CODE, 2012

2018 STATE OF ILLINOIS ACCESSIBILITY CODE 

	PROJEC	T DATA	
ABLE	USE GROUP CLASSIFICATION	F-2	
S AND	CONSTRUCTION TYPE	I-B	
	TOTAL FLOOR AREA	90900SF	
	EXIT ACCESS TRAVEL DISTANCE	184 FT MAXIMUM	
)	AUTOMATIC SPRINKLERS	YES	
)	NEW OFFICE FLOOR AREA	4088 / 200= 20 OC	CUPANTS
)	WAREHOUSE FLOOR AREA	86668/500= 173 00	CCUPANTS
{	TOTAL OCCUPANT LOADS	193 OCCUPANTS	
{	MAXIMUM HEIGHT	1 STORY	
<	REQUIRED NUMBER OF EXITS:	5	ACTUAL 7
\	MINIMUM CORRIDOR WIDTH	48"	

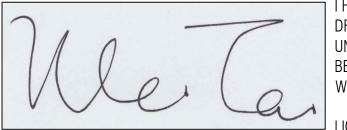

HEREBY CERTIFY THAT THESE DRAWINGS ARE PREEPARED BY ME OR UNDER MY SUPERVISION AND TO THE BEST OF MY KNOWLEDGE CONFORM WITH APPLICABLE CODES.

LIC EXPIRES NOV 30, 2022

2700 GALVIN DRIVE **ELGIN IL 60124** 

2425 S WENTWORTH AVE. CHICAGO IL 60616

PHONE: (312) 912-5798 EMAIL: twarchitect98@yahoo.com

LICENSE NO: 001-022013 EXPIRES: 11/30/2022

236 W ALEXANDER STREET CHICAGO IL 60616

PHONE: (312)720-8800 BILLY WANG68@HOTMAIL.COM LICENSE NO: 062.068227


EXPIRES: 11 / 30 /2023


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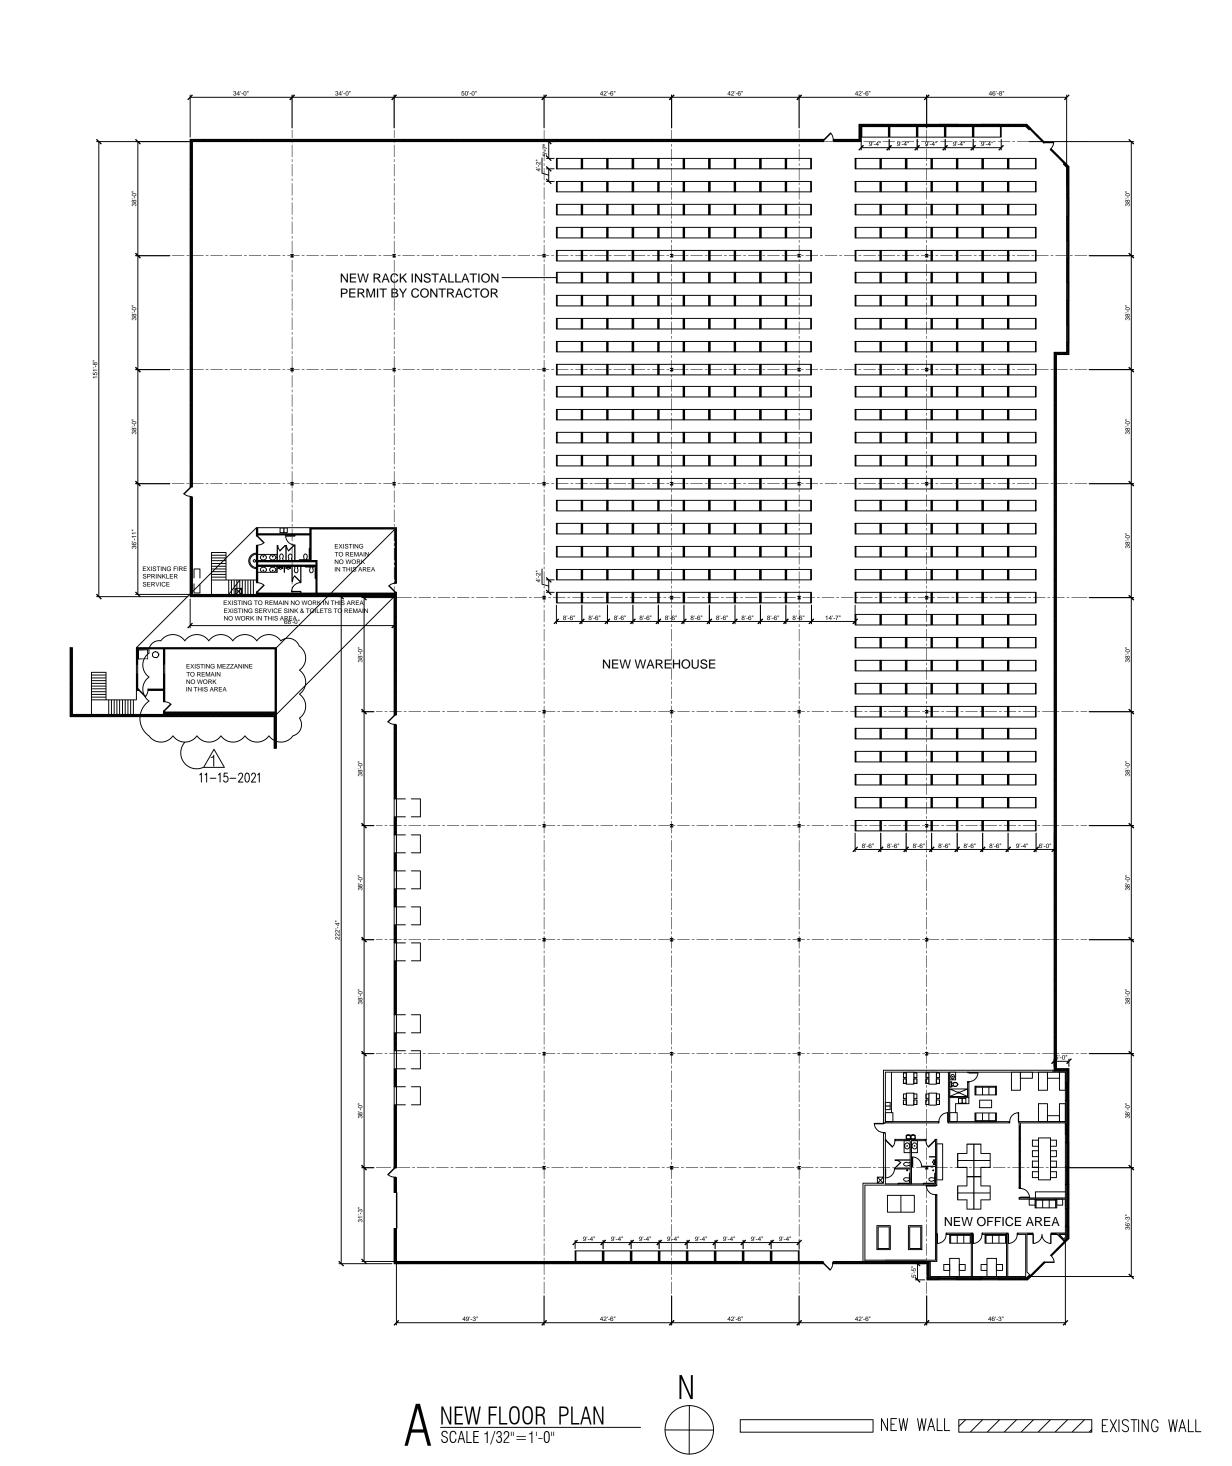
ISSUES	DATE
ISSUED FOR PERMIT	10/08/2021
RE-ISSUED FOR PERMIT	11/15/2021




PROJECT NOTES & SITE PLAN



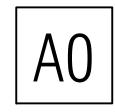

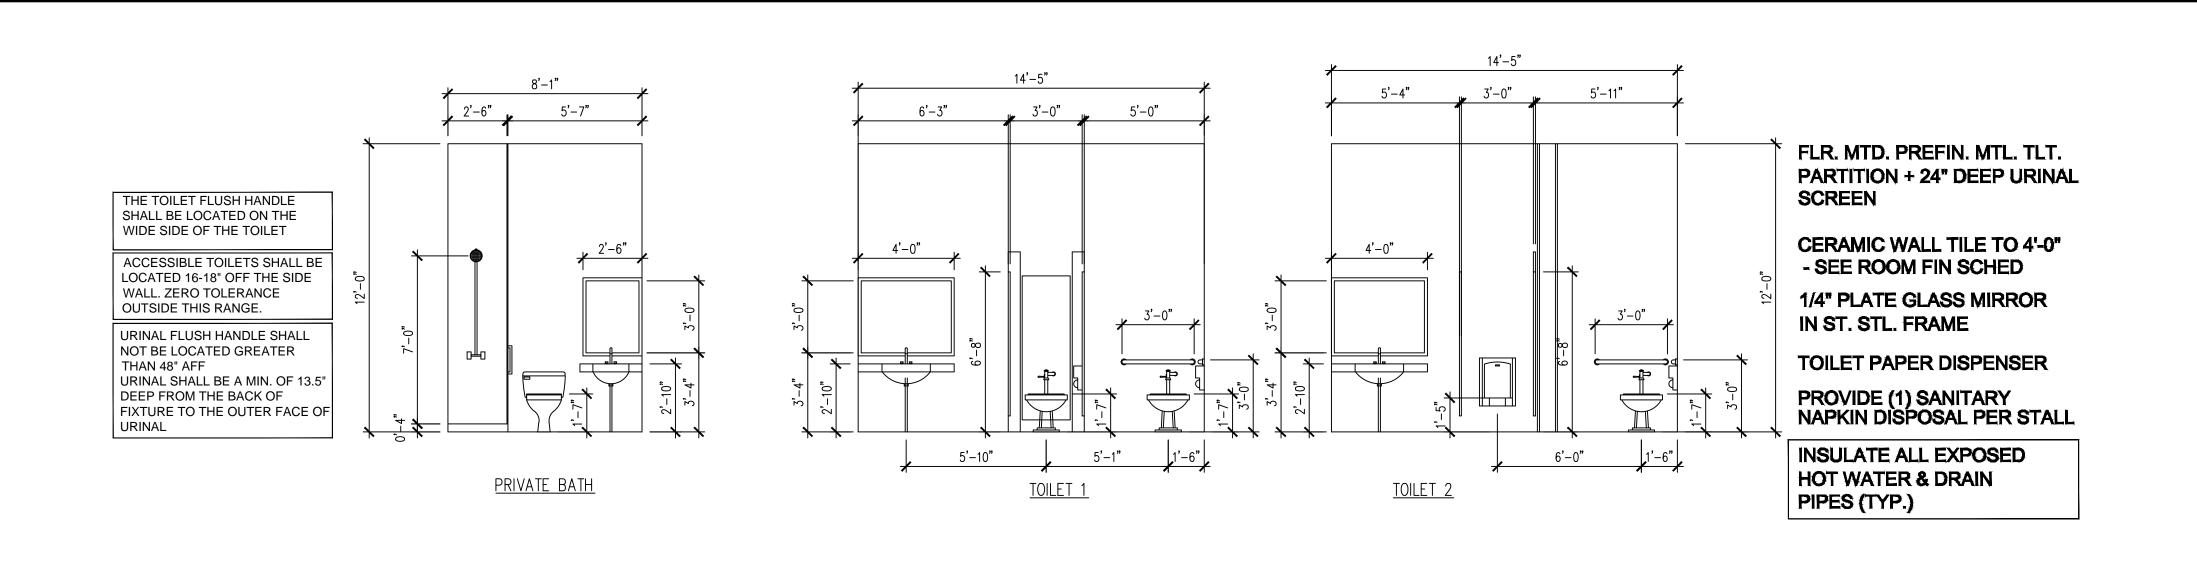

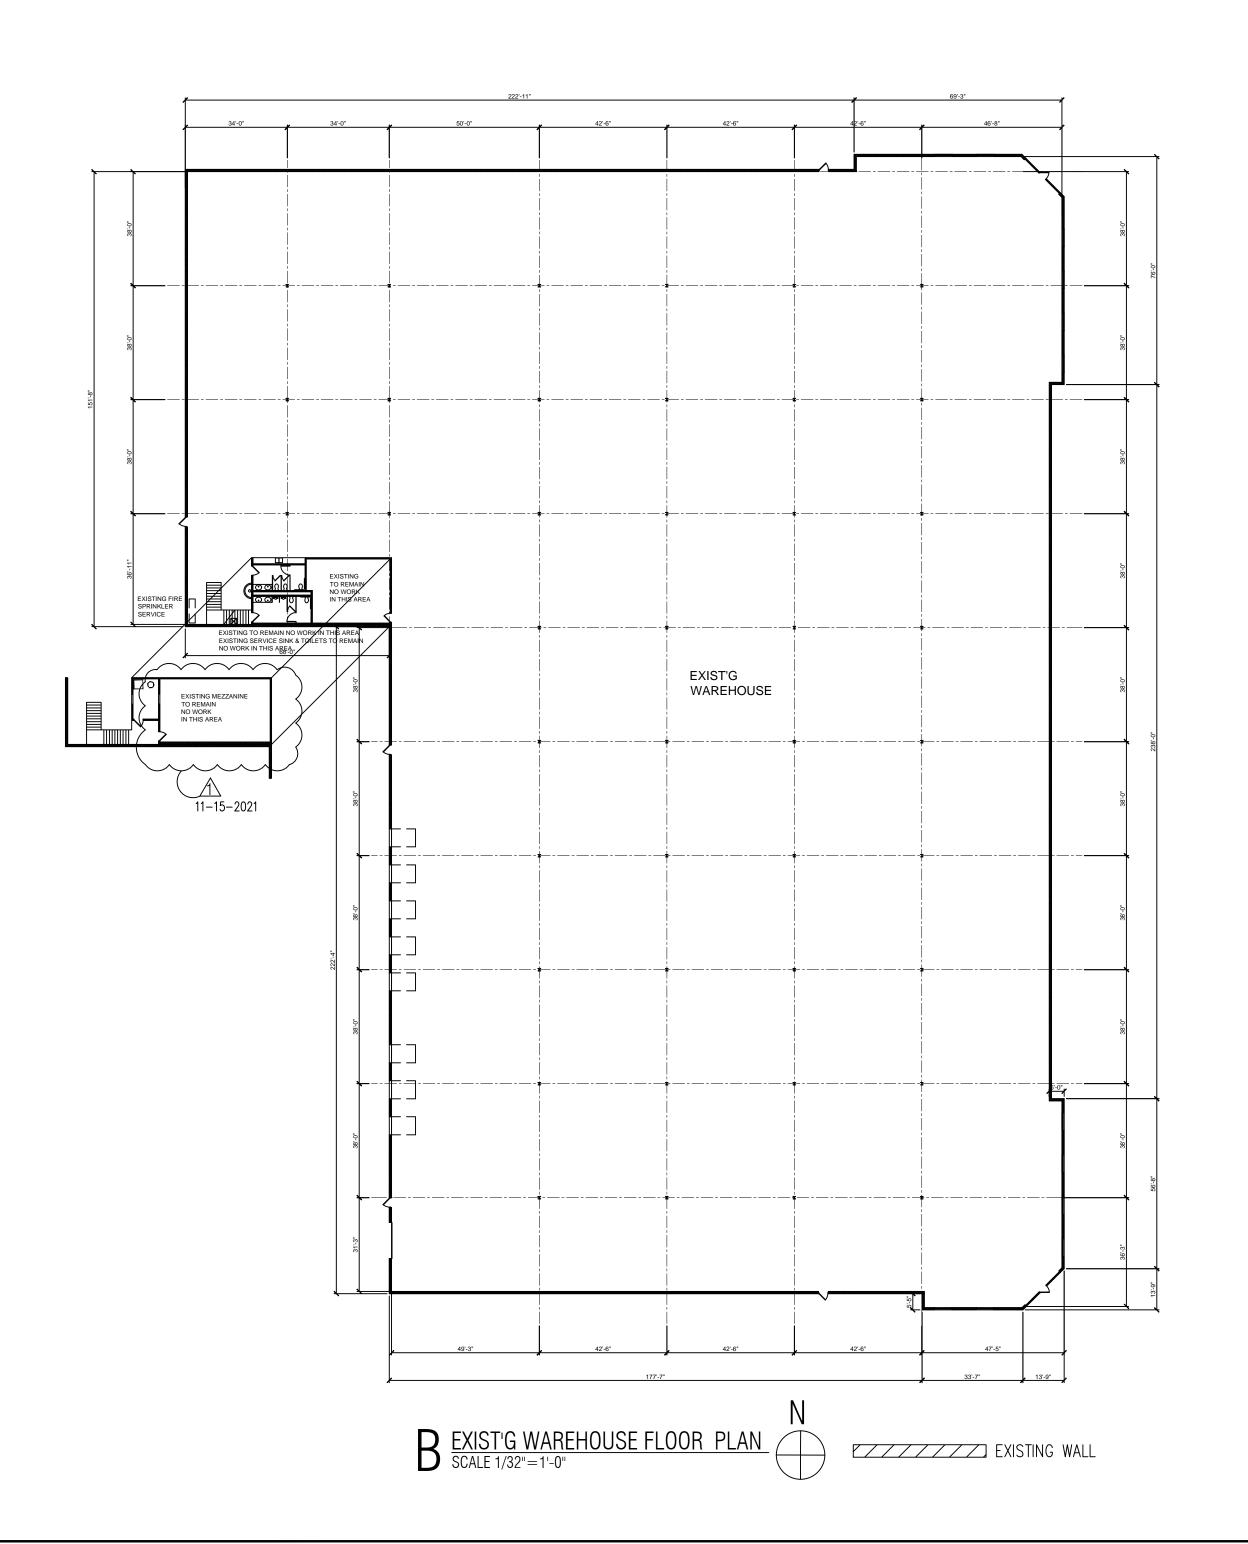

OWNER 2700 GALVIN DRIVE ELGIN IL 60124

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A NEW OFFICE Warehouse Eelgin 11 60124

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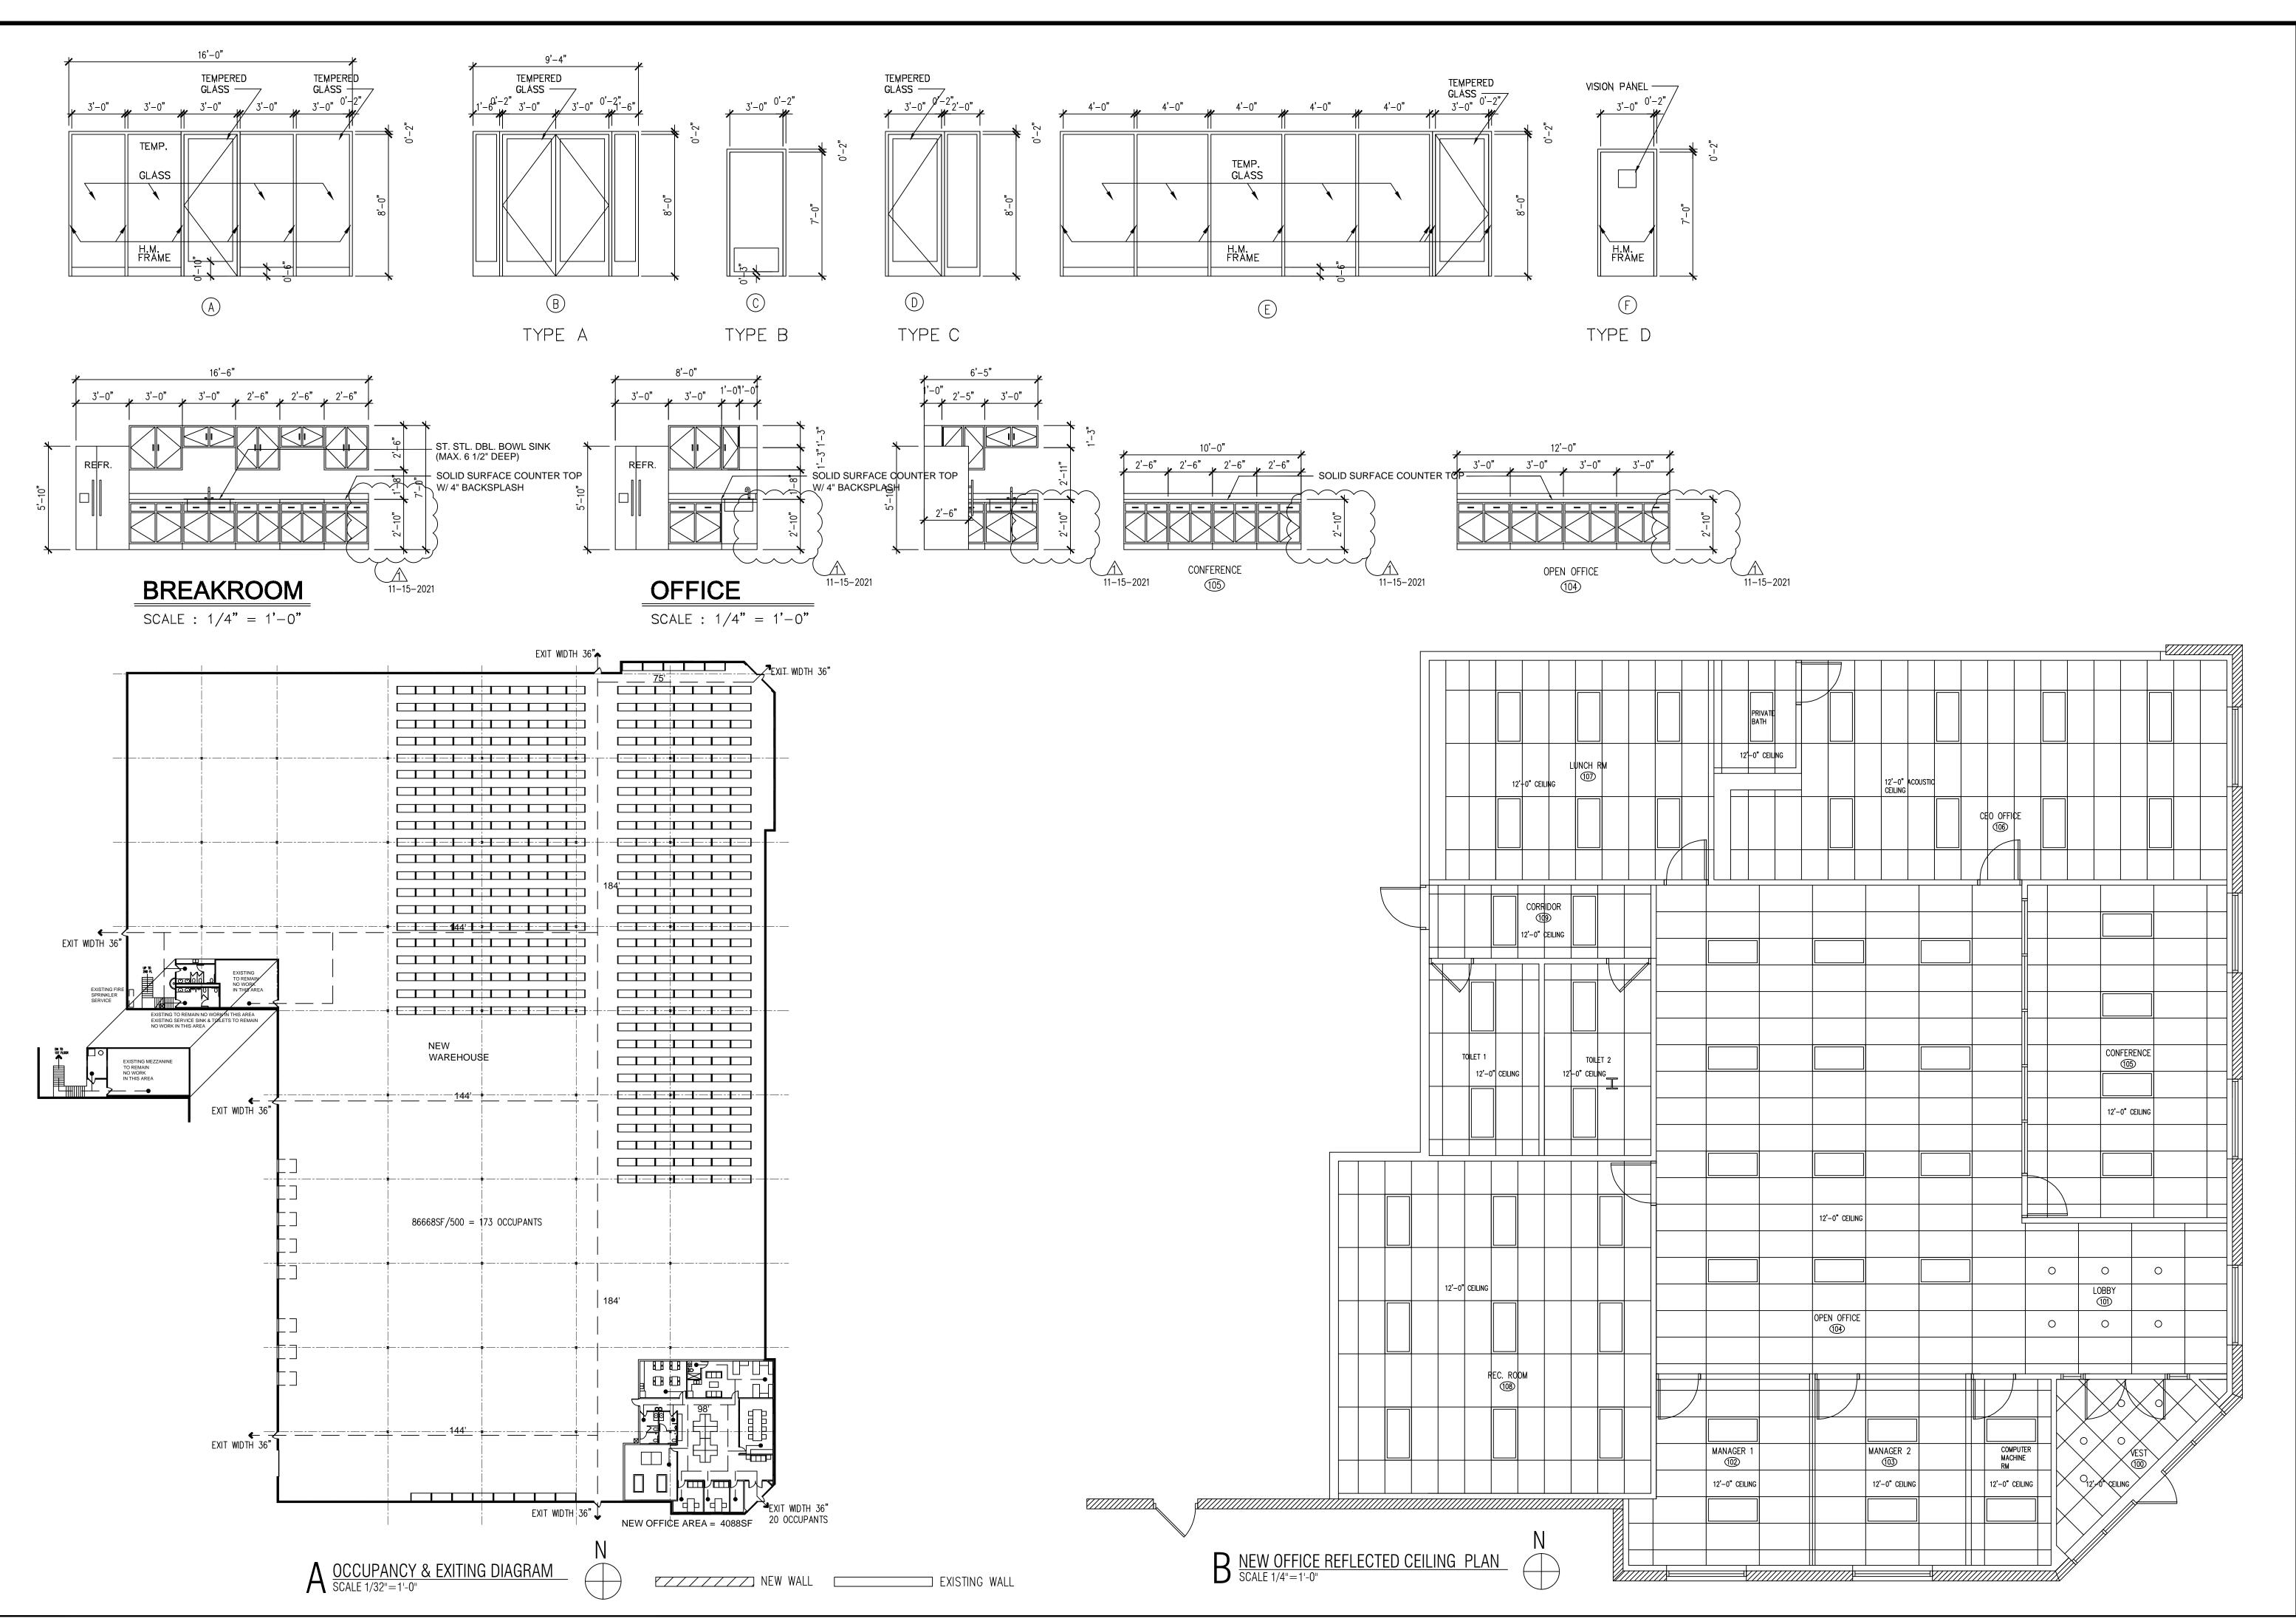
INTERIOR B THE 2700

ISSUES DATE
ISSUED FOR PERMIT 10/08/2021
RE-ISSUED FOR PERMIT 11/15/2021



EXISTING
WAREHOUSE
FLOOR PLAN





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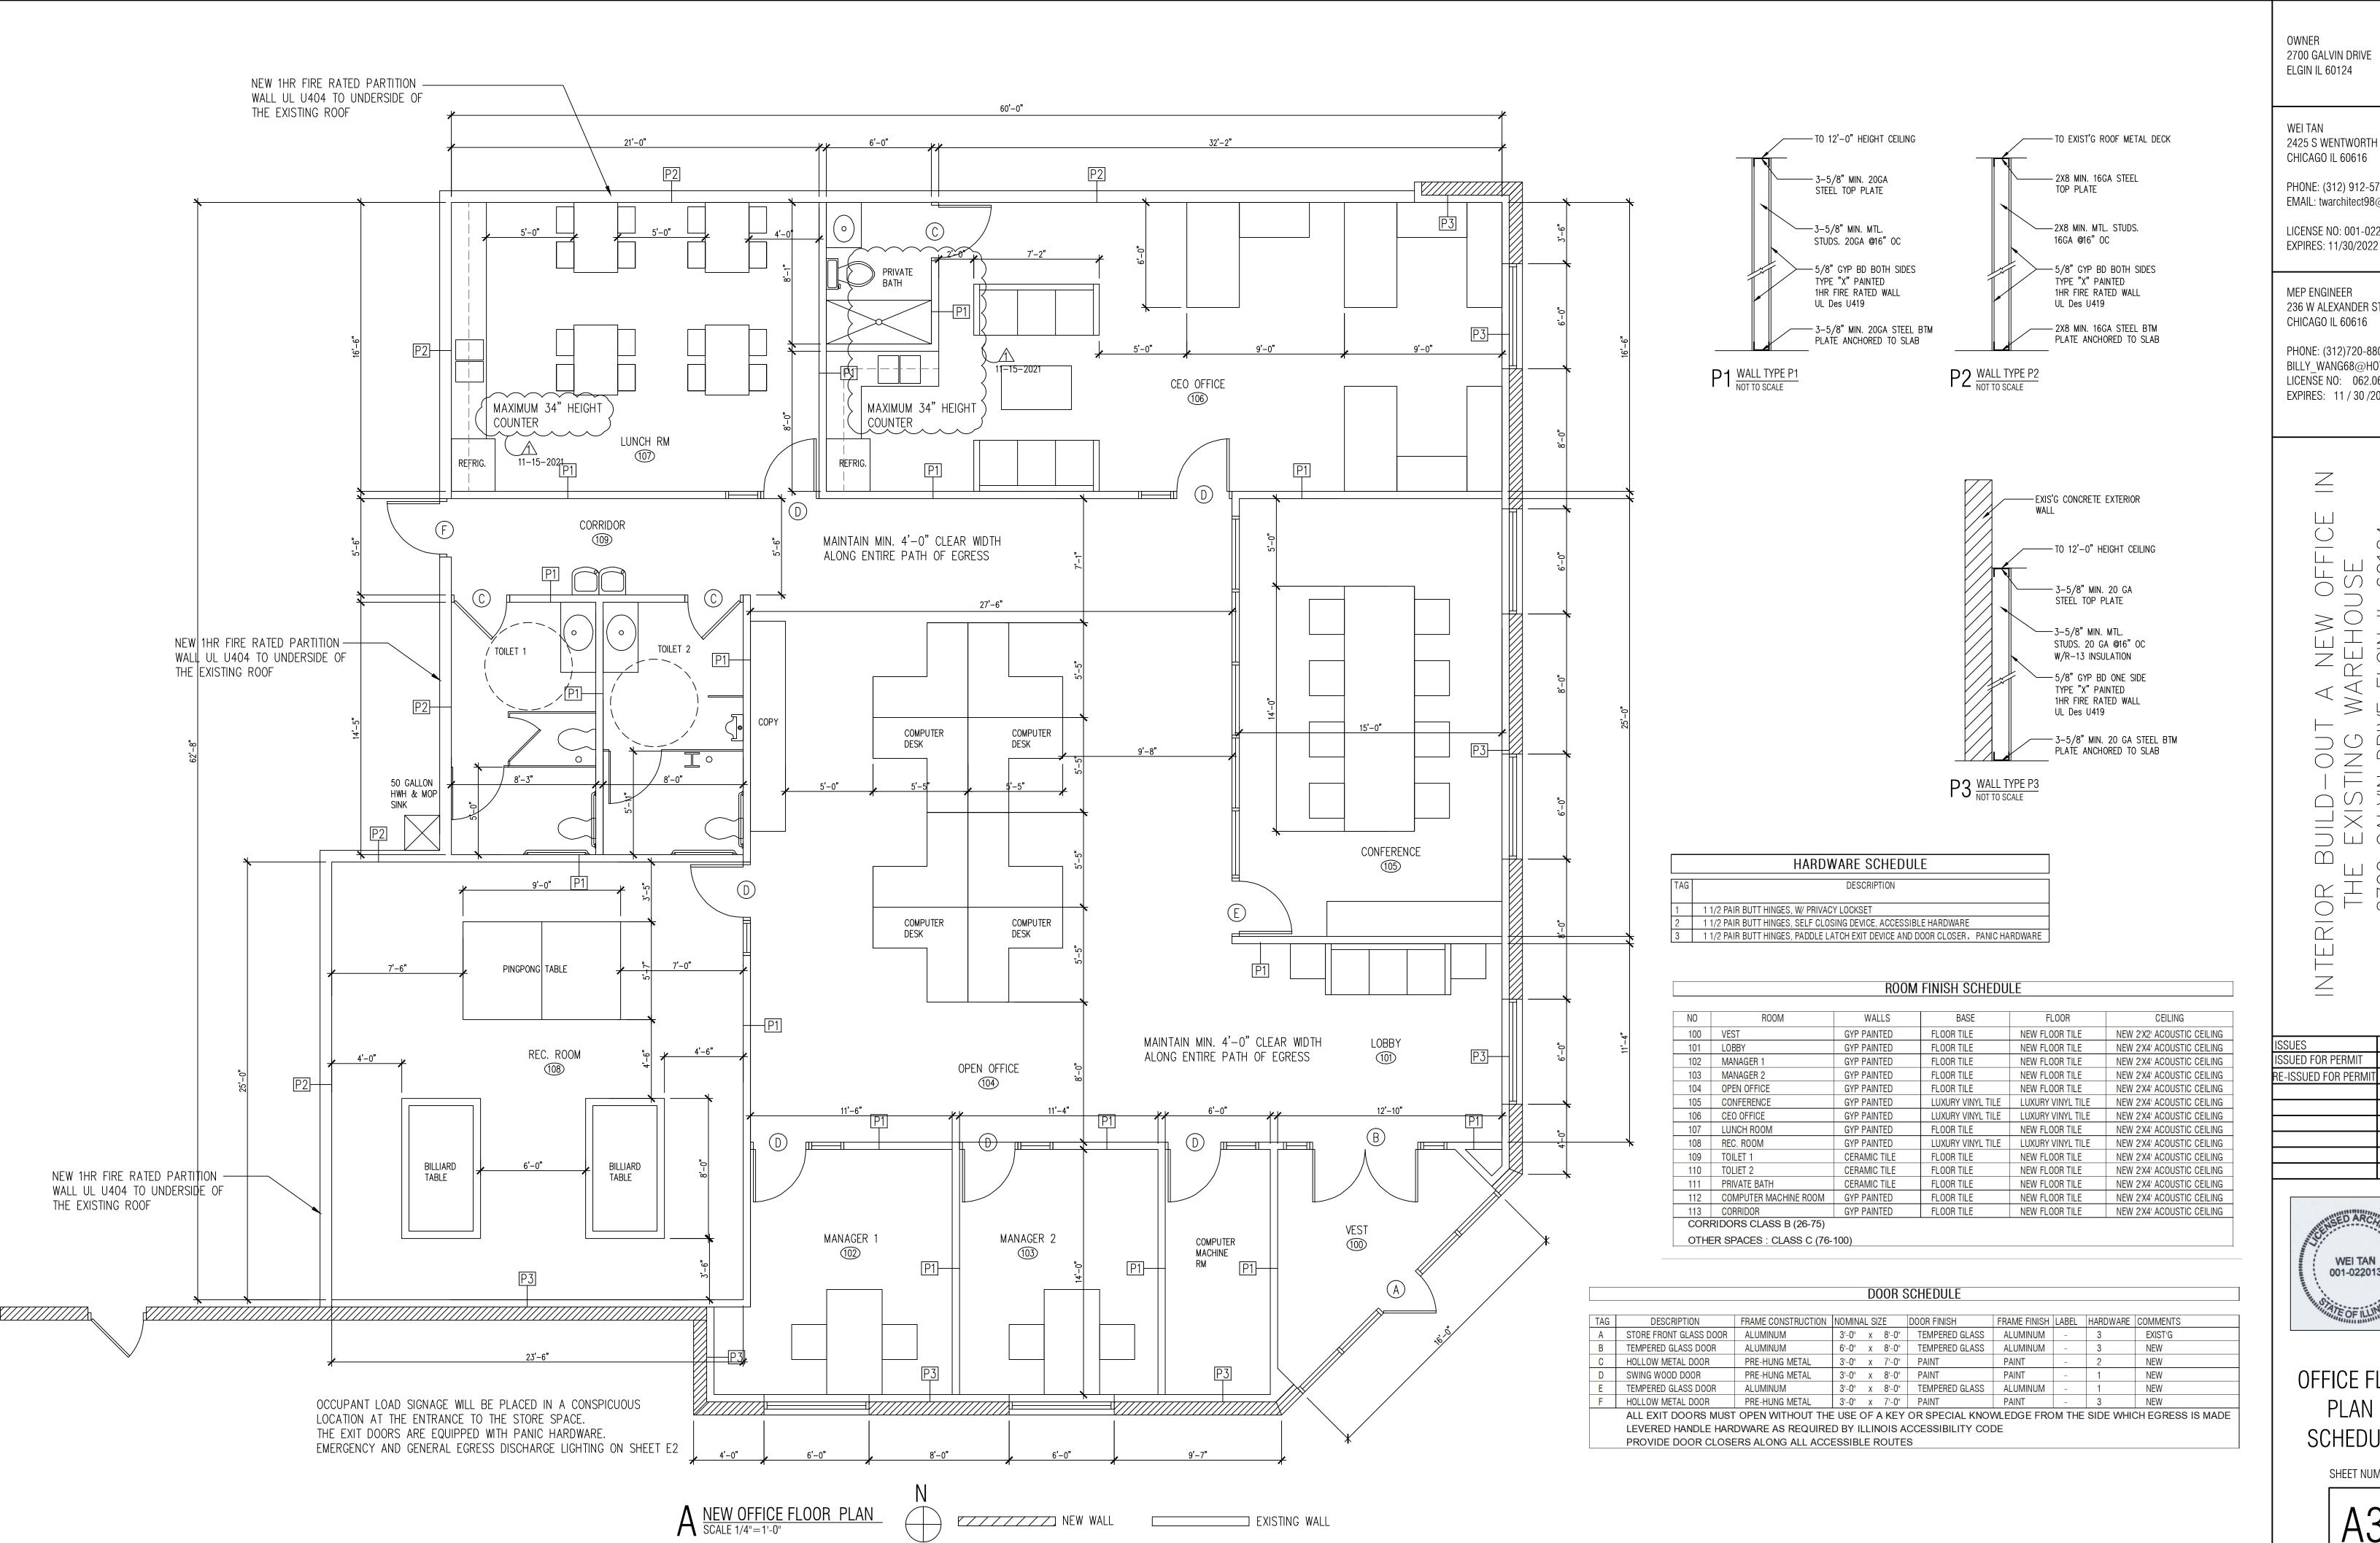
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OCCUPANCY
& EXITING
DIAGRAM
REFLECTED
CEILING PLAN
SHEET NUMBER

A2



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OFFICE FLOOR PLAN & SCHEDULES

# GENERAL ELECTRICAL NOTE:

ELECTRICAL WORK TO BE PERFORMED ON A 'DESIGN BUILD BASIS'.

THE CONTRACTOR SHALL BE RESPONSIBLE FOR THE COMPLETE FOLLOWING THE DESIGN, ENGINEERING AND INSTALLATION OF THE ELECTRICAL SYSTEMS AND EQUIPMENT AND SHALL WARRANTY TO THE OWNER THAT SUCH WORK SHALL ADEQUATELY MEET THE NEEDS AND THE REQUIREMENTS OF THE OWNER AND OF THE PROJECT AS PLANNED AND ITS INTENDED USES AS WELL AS COMPLY COMPLETELY WITH ALL APPLICABLE CODES, ORDINANCES, AND GOVERNING REGULATIONS. IN NO WAY SHALL A DESIGN BUILD ARRANGEMENT LIMIT THE RESPONSIBILITY OF THE CONTRACTOR TO COMPLETE HIS OR HER OBLIGATIONS TO MEET SUCH NEEDS AND REQUIREMENTS.

GENERAL CONTRACTOR SHALL REVIEW LOCATION OF ALL LIGHTING FIXTURES, FANS, AND OUTLETS IN FIELD WITH ELECTRICAL CONTRACTOR PRIOR TO ANY WORK.

DUE TO THIS IS EXISTING BUILDING, THERE ARE MANY RE-MODLATION IN THE OLD ELECTRICAL SYSTEM; THE ELECTRICAL CONTRACTOR IS RESPONSES TO VERY THE **ELECTRICAL WIRING SYSTEM AND MAKE A** NECESSARY CORRECTION AFTER NOTIFY THE OWNER/ENGINEER.

4 WIRE 3PH

2½" RMC

SERVES	A	В	С	AMPS	CK	CK	AMPS	Α	В	С	SERVES
	18400			100	1	2	20	400			WAREHOUSE OUTLET 1
AB-1 SUB PANEL		18400			3	4	20		400		WAREHOUSE OUTLET 2
			18400	3	5	6	20			400	WAREHOUSE OUTLET 3
WAREHOUSE LIGHT 1	12000			20	7	8	15	900			WAREHOUSE OUTLET 4
WAREHOUSE LIGHT 2		12000		20	9	10	15		100		WAREHOUSE OUTLET 5
WAREHOUSE LIGHT 3			12000	20	11	12	15			900	WAREHOUSE OUTLET 6
WAREHOUSE LIGHT 4	12000			20	13	14	15	900			WAREHOUSE OUTLET 4
WAREHOUSE LIGHT 5		12000		20	15	16	15		100		WAREHOUSE OUTLET 5
WAREHOUSE LIGHT 6			12000	20	17	18	15			900	WAREHOUSE OUTLET 6
WAREHOUSE LIGHT 7	12000			20	19	20	125	1200			
WAREHOUSE LIGHT 8		12000		20	21	22			1200		FRONT OFFICE
WAREHOUSE LIGHT 9			12000	20	23	24	/ 3			1200	
WAREHOUSE LIGHT 10	12000			20	25	26	20	1200			
WAREHOUSE LIGHT 11		12000		20	27	28			1200		MUA-2
WAREHOUSE LIGHT 12			12000	20	29	30	/ 3			1200	
	12000			100	31	32	20	1200			
LP-2 SUB PANEL		12000			33	34			1200		EXHAUST FAN-1
			12000	3	00	36	3			1200	
TDANIOEODIAED A	12000			100	37	38	20	1200			EVALUET FAIL O
TRANSFORMER 1		12000			39	40			1200		EXHAUST FAN-2
			12000	3	41	42	/ 3			1200	
SUBTOTAL	90400	90400	78400	1			1	<u> </u>			
TOTAL PANEL LOAD	259200	0	312	AMPS	27	7/480V	3 PH				

	40011077	VIAOCANA	/OD / 41	A/ EI	FOTDIOA	I DA	NIEL	III D. OII				
	480V/277	V/125AMP	/3P/4	W EL	ECTRICA	IL PA	NEL	"LP-Z"				
SERVES		A	В	С	AMPS	СК	CK	AMPS	А	В	С	SERVES
DOCK O	UTLET	2240			20	1	2	30	3360			
DLICK (	DUTLETS		2240		20	3	4			3360		DUCK CHARGE
DOON	JOILETO			2240	3	5	6	3			3360	
		2240			20	7	8	15	2724			WAREHOUSE OUTLET 4
DUCK C	HARGE		2240			9	10	15		2724		WAREHOUSE OUTLET 5
				2240	/ 3	11	12	15			2724	WAREHOUSE OUTLET 6
		2240			20	13	14	30	3360			
DUCK C	HARGE		2240			15	16			3360		DUCK CHARGE
				2240	/ 3	17	18	3			3360	
		3360			30	19	20	25	2240			
#5; #6	DUCK CHARGE		3360			21	22			2240		#1; #2 DUCK CHARGE
				3360	/ 3	23	24	/ 3			2240	
		3360			30	25	26	20	2240			
#7; #8	DUCK CHARGE		3360			27	28			2240		#3; #4 DUCK CHARGE
				3360	/ 3	29	30	/ 3			2240	
SUBTO	ΓAL	13440	13440	13440					13924	13924	13924	
TOTAL	PANEL LOAD	82092	0	99	AMPS	277	7/480V	3 PH				

SERVES	А	В	C	AMPS	CK	CK	AMPS	Α	В	С	SERVES
	2240			20	1	2	20	1200			WAREHOUSE LIGHT 11
BATTERY CHARGE 1		2240			3	4	20		1200		WAREHOUSE LIGHT 12
			2240	3	5	6	20			1200	WAREHOUSE LIGHT 13
	2240			20	7	8	20	2240			
BATTERY CHARGE 2		2240			9	10			2400		BATTERY CHARGE 4
			2240	3	11	12	3			2240	·
	2240			20	13	14	20	1200			WAREHOUSE LIGHT 11
BATTERY CHARGE 3		2240			15	16	20		1200		WAREHOUSE LIGHT 12
			2240	3	17	18	20			1200	WAREHOUSE LIGHT 13
SUBTOTAL	6720	6720	6720					4640	4800	4640	
TOTAL PANEL LOAD	34240	0	41	AMPS	277	7/480V	3 PH				

# EXIST ELEC. PANEL. NO WORK.

120V/208V/2	00AMP	/3P/4	W EL	ECTRIC/	AL PA	NEL	"RP-1"				
SERVES	Α	В	С	AMPS	СК	CK	AMPS	А	В	С	SERVES
DUCK OUTLET	1200			20	1	2	20	1200			WAREHOUSE OUTLET 1
DUCK OUTLET		1200		20	3	4	20		1200		WAREHOUSE OUTLET 2
DUCK LEVEL 1			1200	20	5	6	20			1200	WAREHOUSE OUTLET 3
DUCK LEVEL 2	1200			20	7	8	15	1200			WAREHOUSE OUTLET 4
DUCK LEVEL 3		1200		20	9	10	15		1200		WAREHOUSE OUTLET 5
DUCK LEVEL 4			1200	20	11	12	15			1200	FIRE ALARM
	1200			20	13	14	20	1200			OFFICE OUTLET 1
GARAGE DOOR OPENING		1200			15	16	20		1200		COUNTTOP OUTLET
			1200	/ 3	17	18	20			1200	OFFICE OUTLET 2
DUCK LOW LEVEL LIGHT	1200			20	19	20	20	1200			OFFICE OUTLET 3
DUCK LOW LEVELOUTLET 1		1200		20	21	22	20		1200		MAN'S HAND DRYER
DUCK LOW LEVEL OUTLETY 2			1200	20	23	24	2	_		1200	· · · · · · · · · · · · · · · · · · ·
CONTROL CIRCUIT	1200			20	25	26	35	3640			SECOND FLOOR AC-UNIT
SECOND FLOOR OFFICE LIGHTS		1200		20	27	28	2		3640		<del>, , , , , , , , , , , , , , , , , , , </del>
SECONF FLOOR FURANCE			1200	20	29	30	20			1200	,
SECOND FLOOR KITCHEN OUTLET	1680			20	31	32	20	1680			WAREHOUSE OUTLET 3
				20 20	33	34	20		1680		WOMAN'S HAND DRYER
				20	35	36	2			1680	
					37	38	20	1200			KITCHEN OUTLET 1
	_			20 20	39	40	20		1200		KITCHEN OUTLET 2
AUDTOT II		00	0.5	20	41	42	20			1200	KITCHEN OUTLET 3
SUBTOTAL	7680	6000	6000		<u> </u>			11320	11320	7680	

## **Service Load Calculation** Commercial

Address: 2700 GALVIN DRIVE, ELGIN IL Outside Building Dimensions: Length 378' Width 225' Floors 1\_ ADD Length 145' Width 68' Floors 1\_

Type of Electrical Service: 400 Phase 3 Wire 4 Volt480/277Ampere/s 400

Service Conductors 14-28-1480 Size 500 Type CU (Al.,Cu),ConduitRMC IMC,Rigid GENERAL LIGHTING LOAD:

> Square foot area per floor: 94910 Total square foot area : 94910

Times(1.3 Watts)per square foot 123383 Other loads(receptacles)

(See section 14-16-180(b)) <u>33</u> Times(180 Watts) 5,940

ADD

47520 19680 (1) LP-2 EXIST SUB ELECTRICAL PANEL 480V/3PH/100A (1) AB-1 SUB ELECTRICAL PANEL 480V/3PH/100A 20640 28912 (1) LP-3 NEW SUB ELECTRICAL PANEL 480V/3PH/100A (1) RP-1 EXIST SUB ELECTRICAL PANEL 120V/1PH/200A

MOTOR LOAD ON MAIN ELECTRICAL PANEL LP-1


(1) EXHAUST FAN 1 (EXISTING) 6720 6720 (1) EXHAUST FAN 2 (EXISTING) (1) MAKE UP AIR UNIT (EXISTING)

> <u>26623</u>5 VA **Total Watts:**

TOTAL LOAD:  $I = W/(v \times 1.732) = 320 \text{ AMP}$ 

USE 400 AMP MULTIPLY BY 80% FOR CONSIDERATIONS OF CONTINUOUS LOADS, SERVICE SIZE TO BE 570 AMP 277/480V 3PH, 4WIRE

EXISTING SERVICE SIZE IS 400 AMP

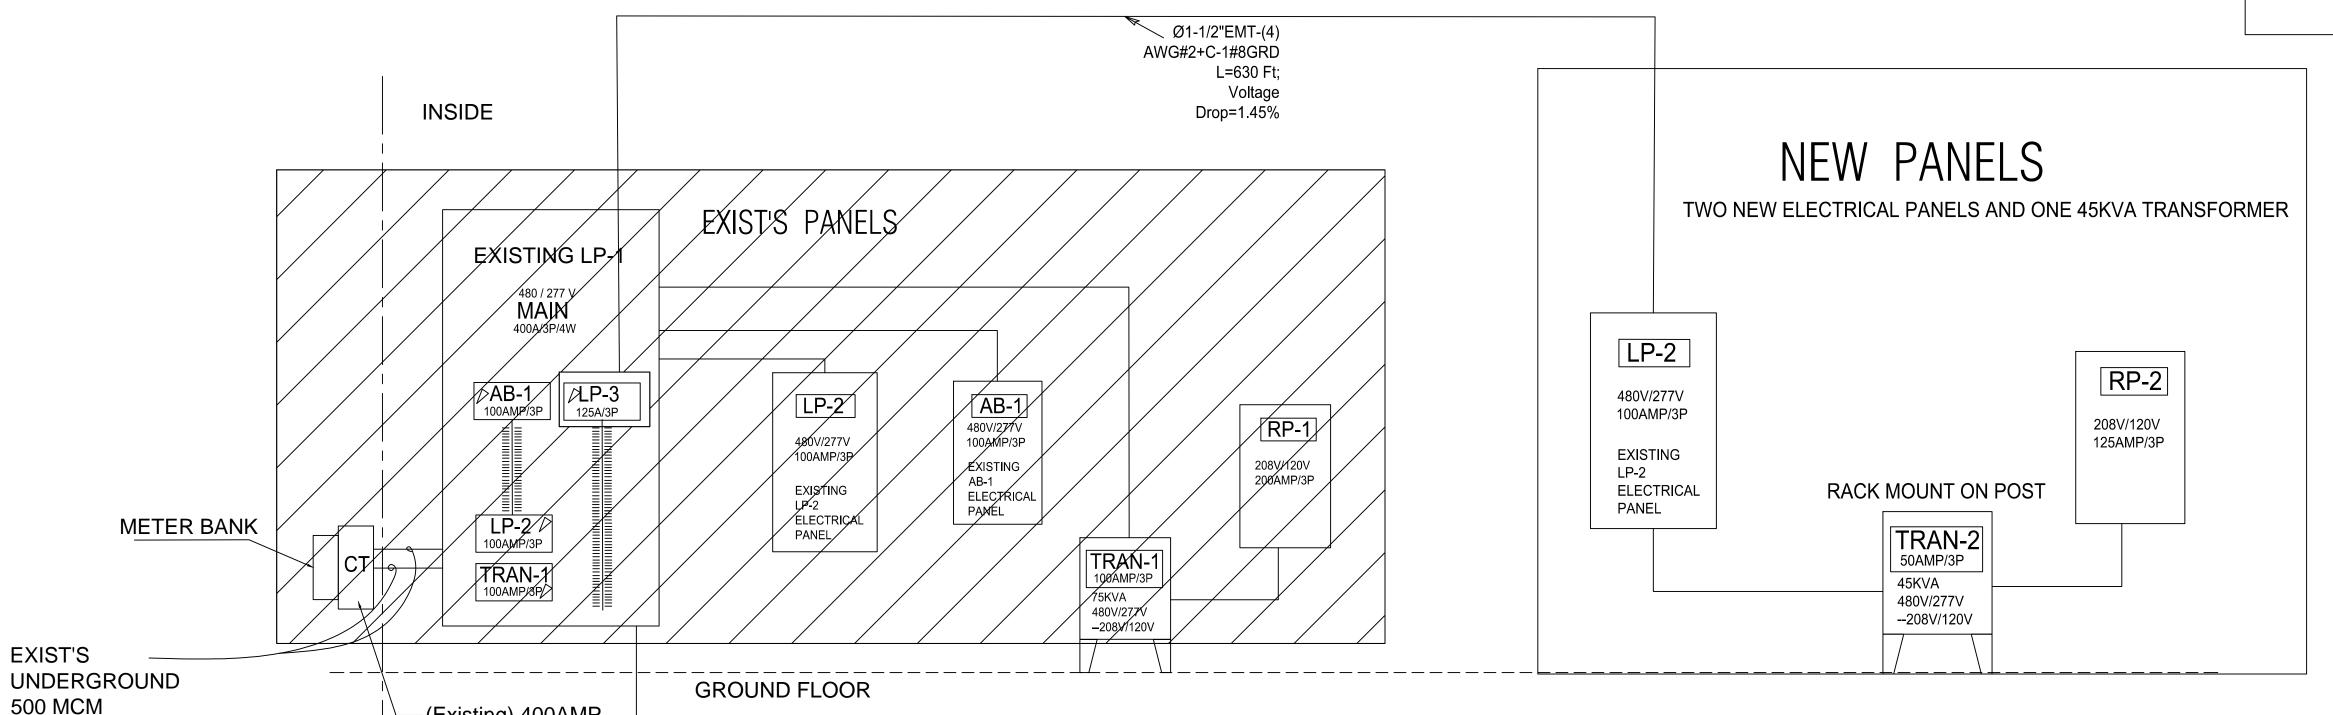

SINGLE LINE DIAGRAM SCALE: N.T.S.

**EXIT SIGN&EMERGENCY LIGHTING SCHEDULE** DESCRIPTION SYMBOL LAMPS REMARKS BATTERY OPERATED EMERGENCY LIGHT 'SURE-LITES' CAT. No. EAC- 4201-3,9,21,24; DOUBLE PL5-5 WATT FLOURESCENT OR2XT6 1/2-20WATT INCANDESCENT PROVIDE REMOTE BATTERY OPERATED EM. LIGHT 12W SURE-LITES XR-6-C (212H6V) HALOGEN LAMPS WHERE INDICATED WHEATER PROOF 8W, 6V REMOTE HALOGEN LAMP SURE-LITES 6T-8-W BATTERY FOR REMOTE LAMPS SURE-LITES XR-8 RATED @ 1 1/2 HRG, 54 WATTS

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 $\bar{\bigcirc}$  Z EXI GAL INTERIOR THE 2700

SSUED FOR PERMIT 10/08/2021 E-ISSUED FOR PERMI COF ILLINO XIAO BAI 062.068227

> **ELECTRICAL** SINGLE LINE AND LOADING CALCULATION SHEET NUMBER


CELL: 312-720-8800


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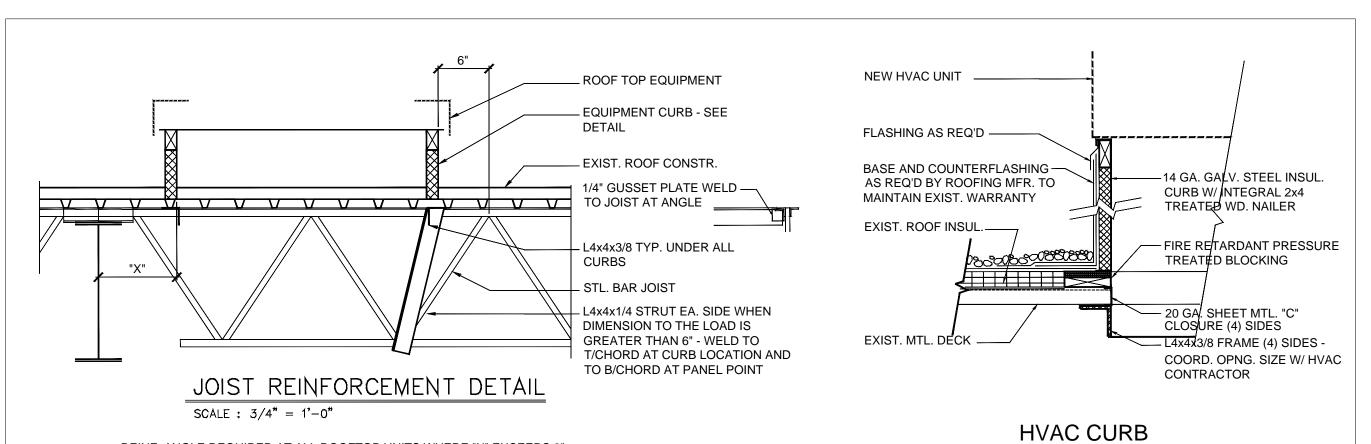
NOTE: THE ELECTRICAL CONTRACTOR RESPONSES TO VERIFY THESE EXISTING PANELS WIRE CONNECTIONS AND MARK OUT THE DIFFERENCE ON ELECTRICAL PANELS AS LOCAL ELECTRICAL CODE REQUIRED.

-(Existing) 400AMP

**CT CABINET** 



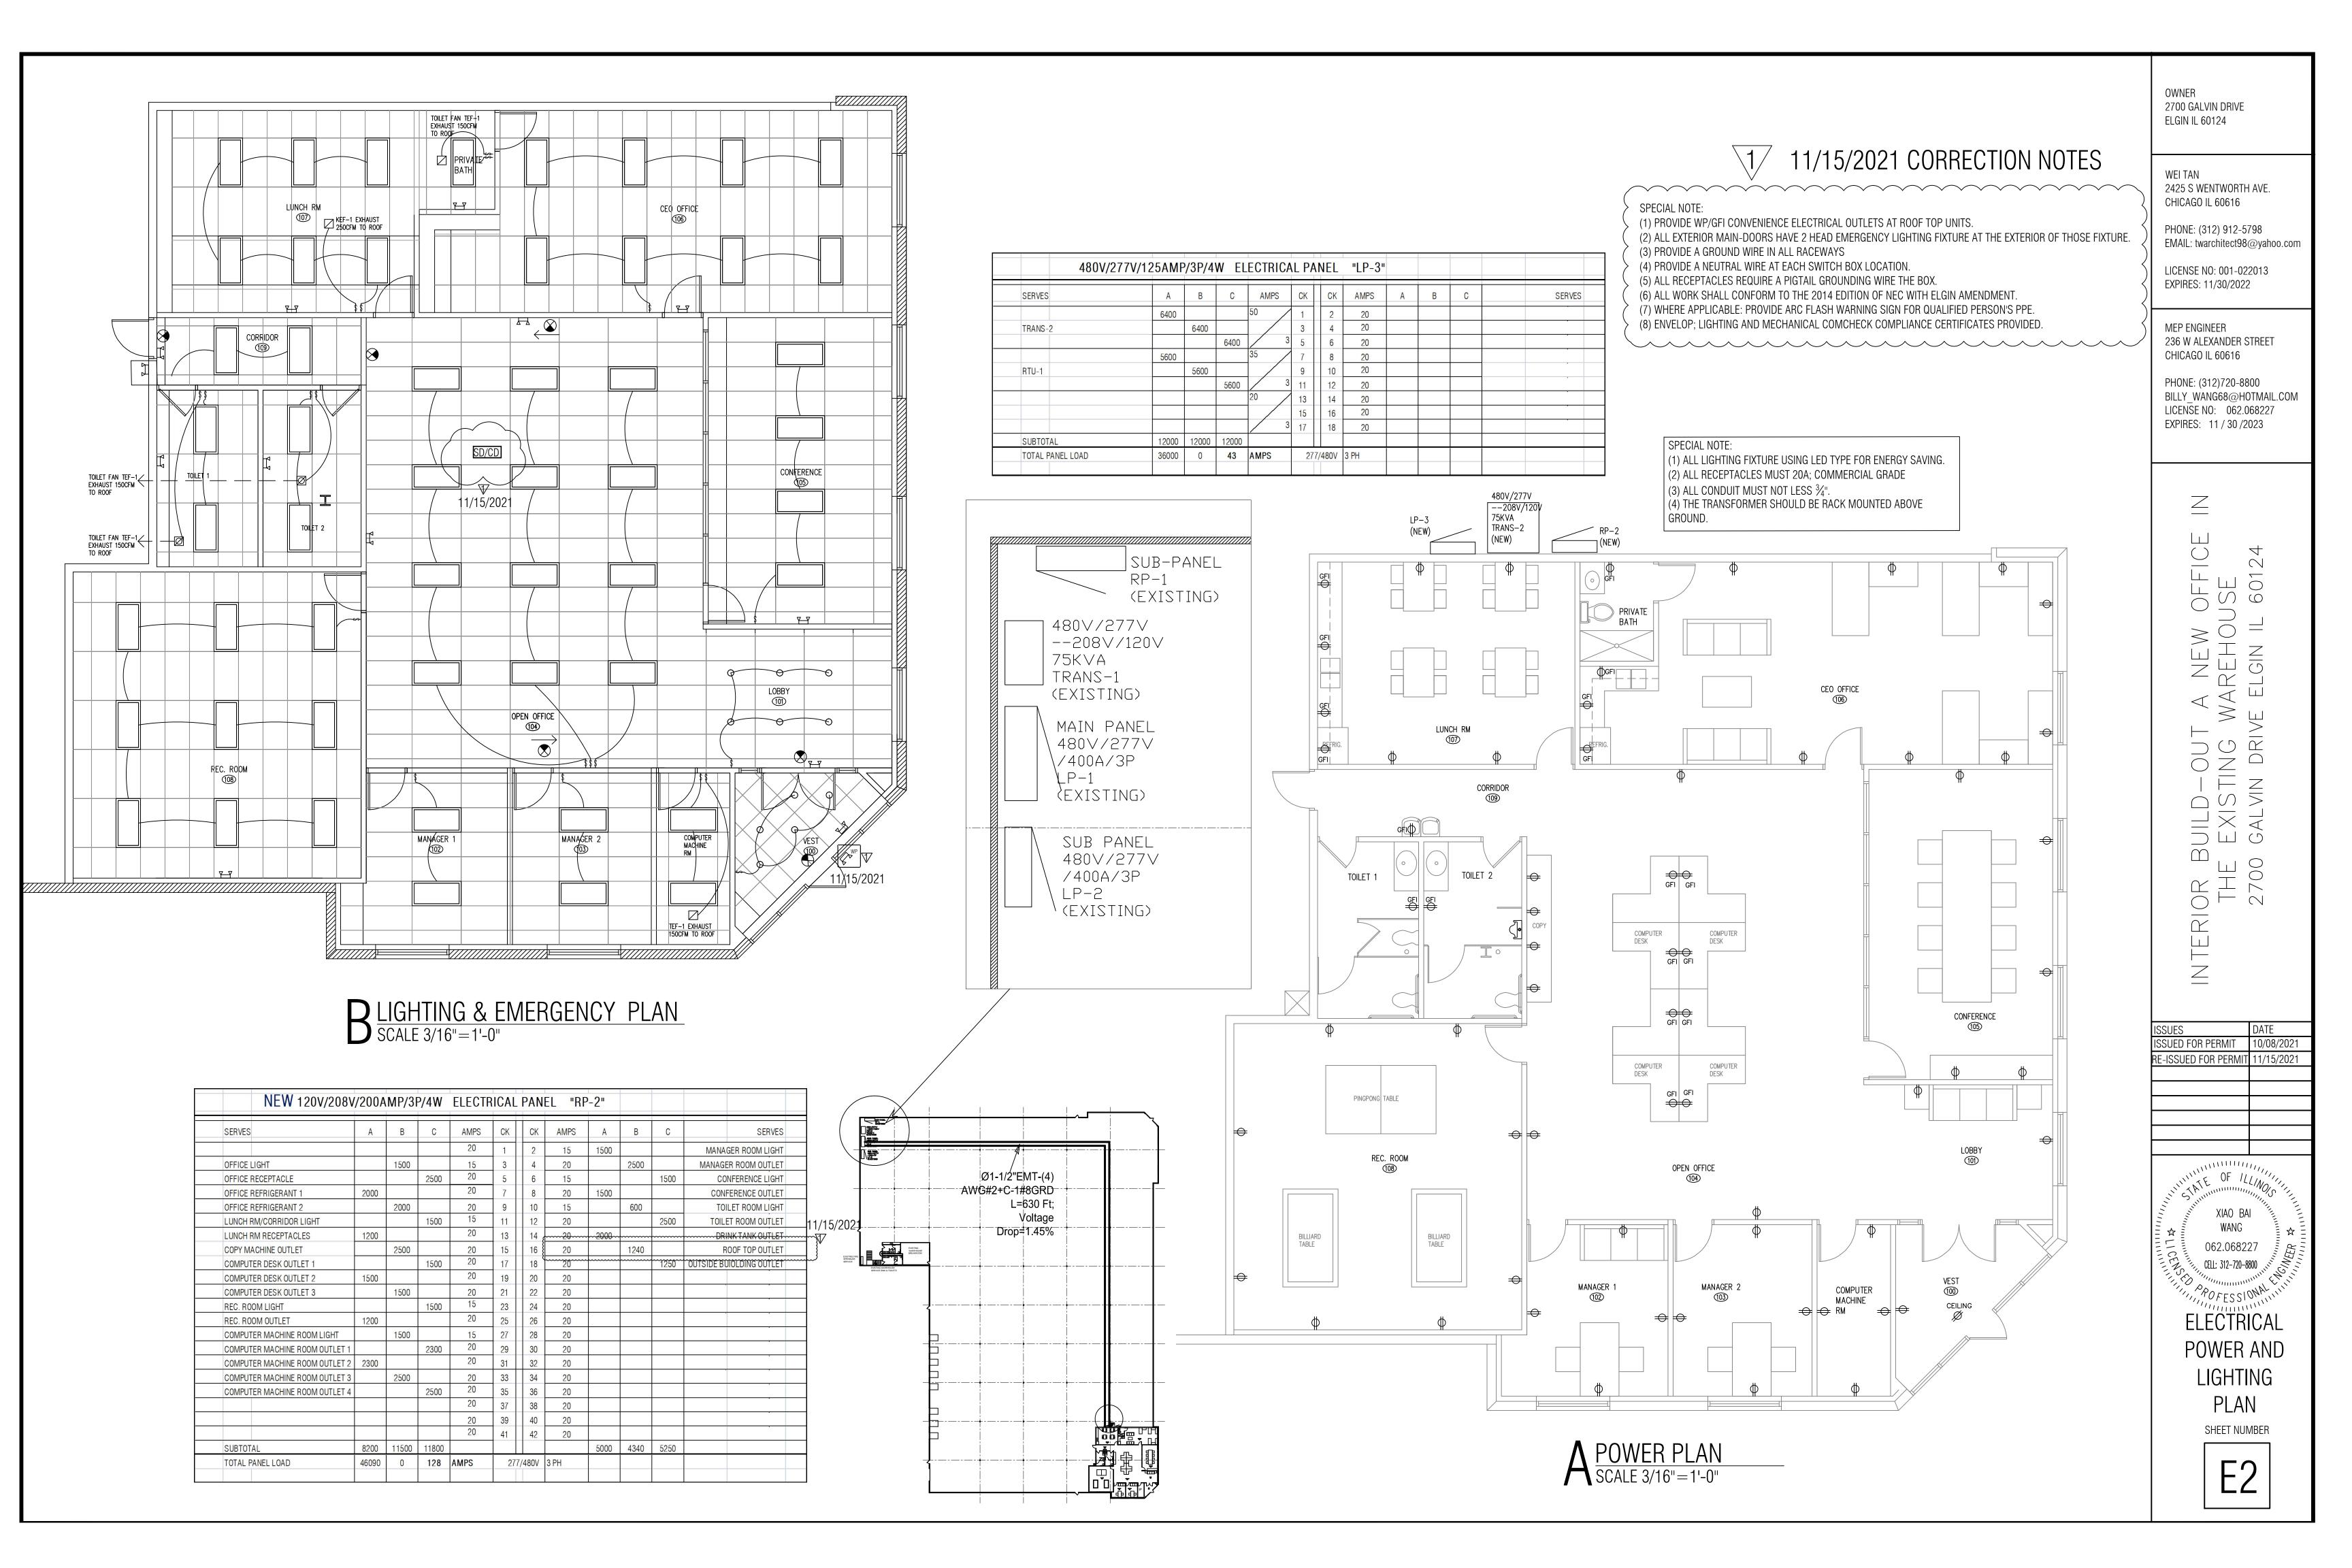

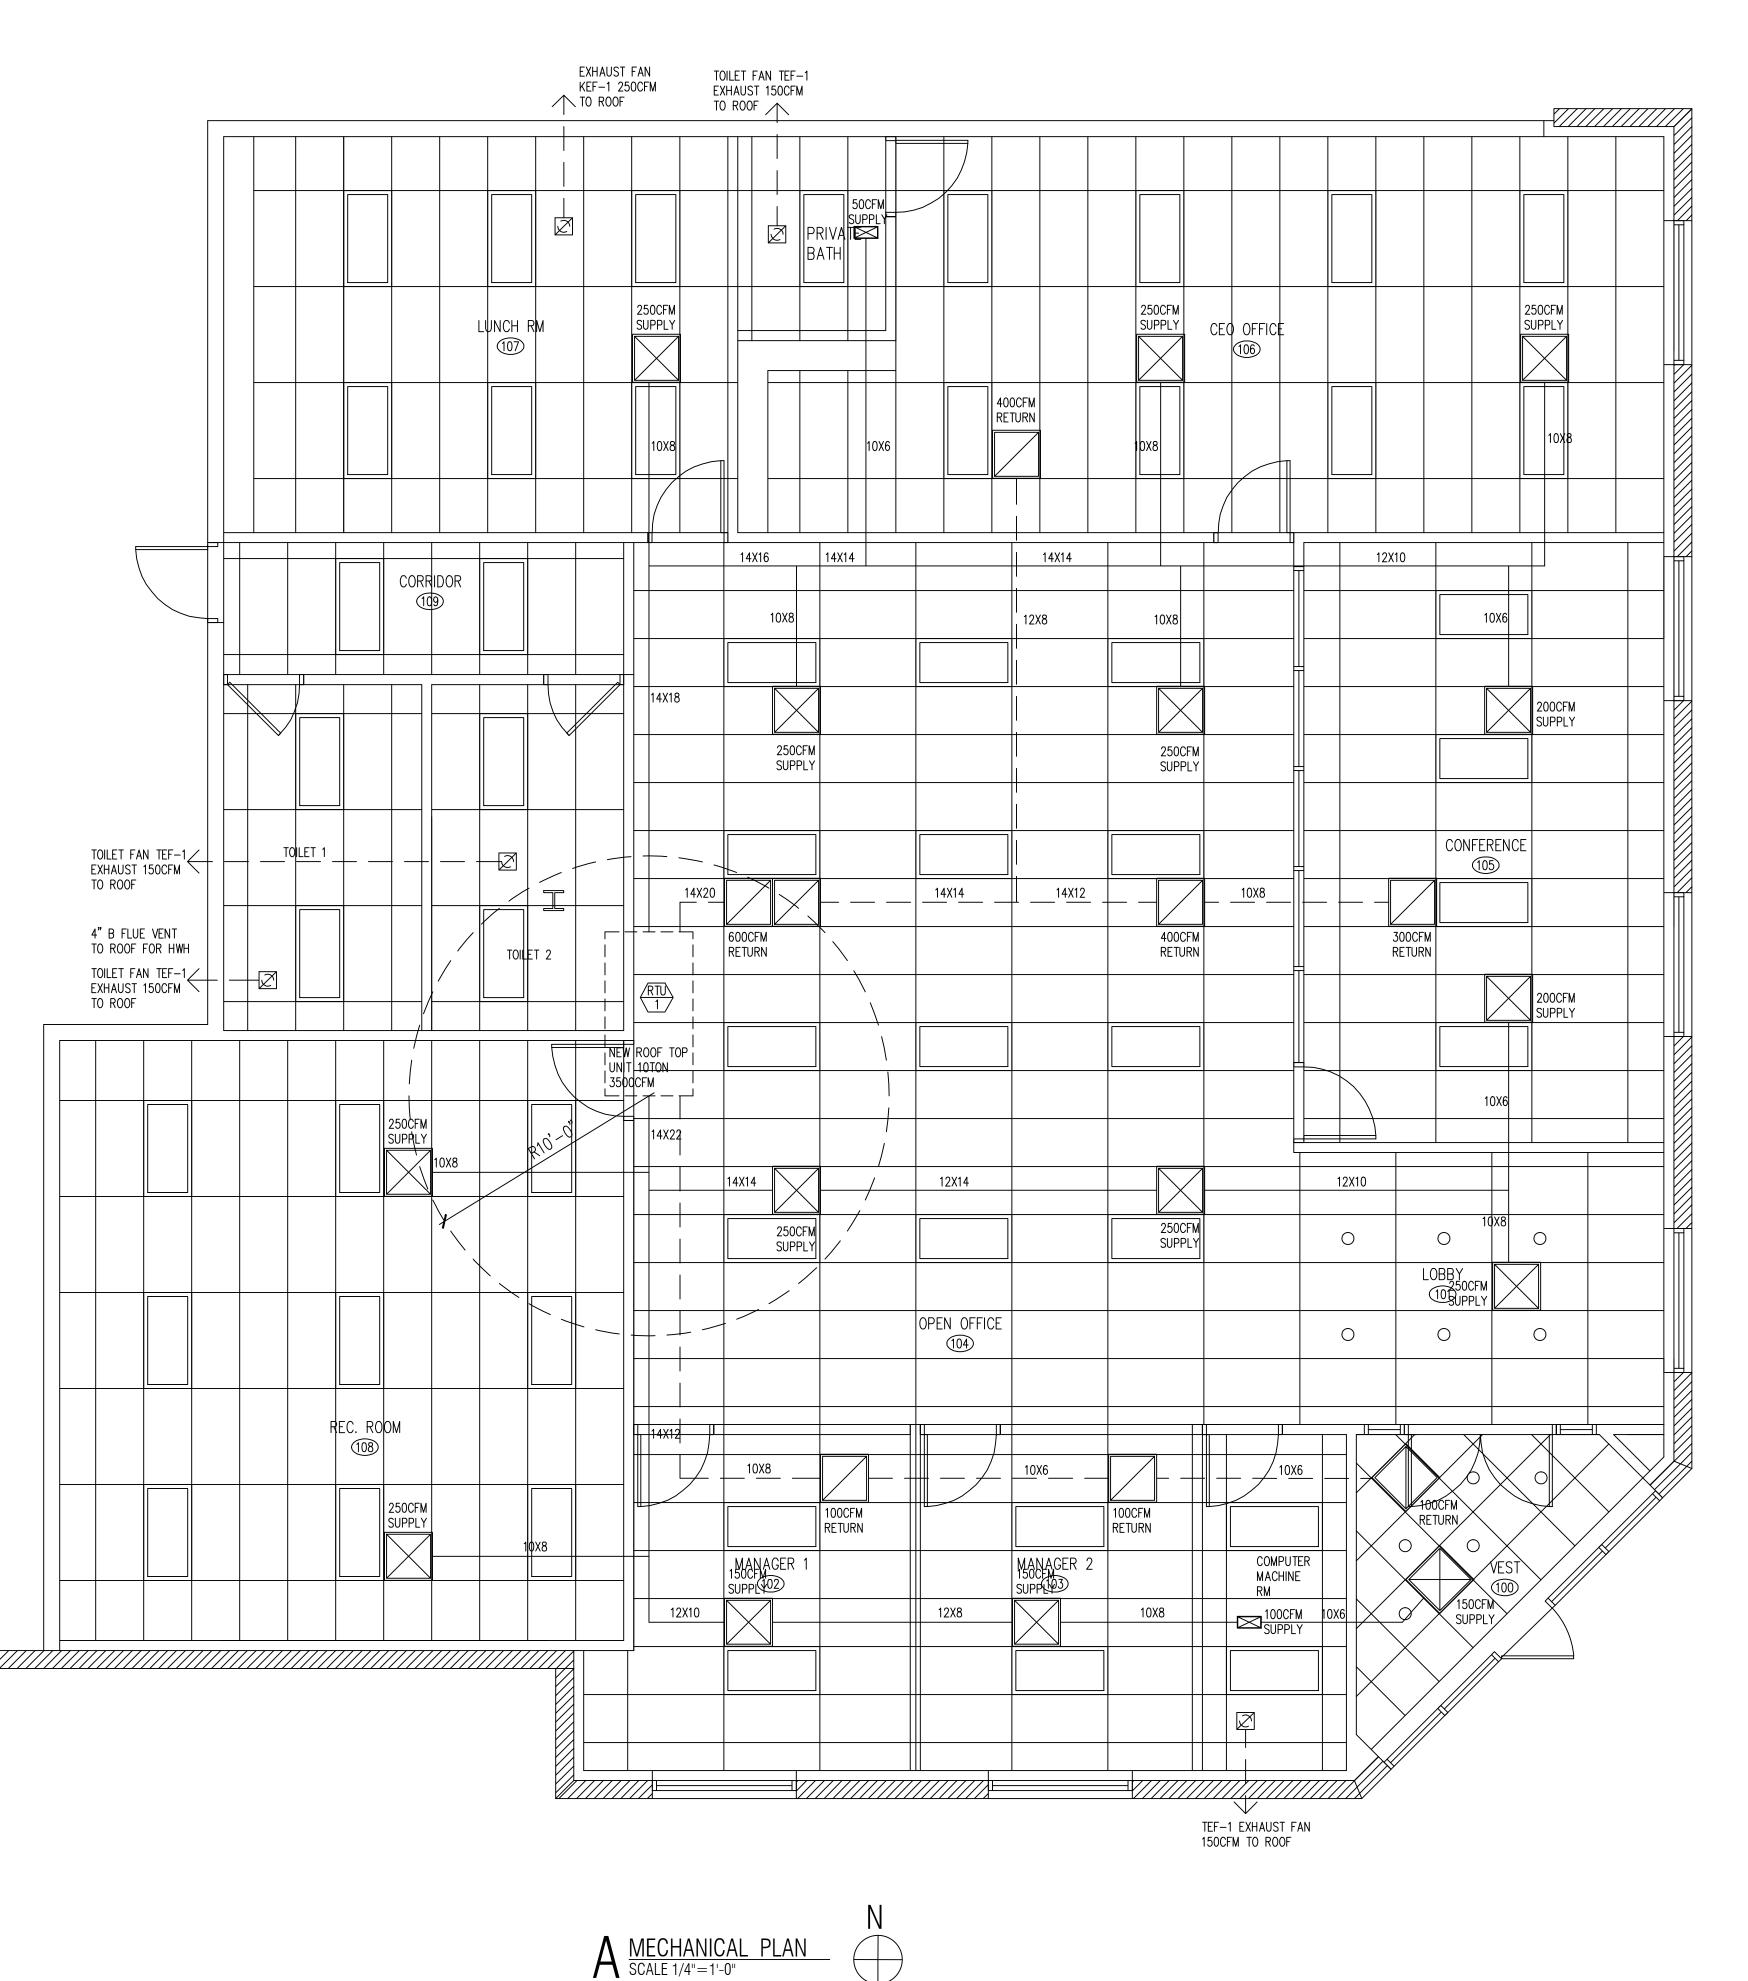

	DIFFUSER, GRILL, REGISTER SCHEDULE									
TAG	TAG MANUF. MODEL TYPE FACE SIZE L X W FRAME TYPE									
Α	TITUS OR EQUAL	OMNI-AA	SUPPLY W/ INTEGRAL DAMPER	24" x 24"	DIRECT					
В	TITUS OR EQUAL	PXP	RETURN W/ OPPOSED BLADE DAMPER	24" x 24"	DIRECT					

REINF. ANGLE REQUIRED AT ALL ROOFTOP APPLIED CONCENTRATED LOADS NOT

REINF. ANGLE REQUIRED AT ALL ROOFTOP UNITS WHERE "X" EXCEEDS 8"

OCCURING AT JOIST PANEL POINTS

	REFRIGERATION SCHEDULE										
TAG	TAG DESCRIPTION QTY LOCATION REF. USED WT. OF REF. RATED HP NO. OF REMOTE/ SELF WATER AIR LBS (TONS) COMP CONTAINED COOLED COOLED										
RTU-1	NEW	1	ROOF	R-410A	10LBS	10	1	1	SELF CONTAINED	-	YES

	MECHANICAL EQUIPMENT SCHEDULE										
TAG	QUAN	LOCATION	MANUFACTURER	MODEL	CFM	VOLTAGE	HP	MOP			
TEF-1	4	ROOF	BY OWNER	BY OWNER	150	1PH	1/20	20AMP	TOILET ROOM EXH		
RTU-1	1	ROOF	BY OWNER	BY OWNER	3500	3PH	3	60AMP	210,000 BTU INPUT		
KEF-1	1	ROOF	BY OWNER	BY OWNER	250	1PH	1/20	20AMP	LUNCH RM		

		NEV	V OFFICE	ON SCH	IEDULE					
					MECHA	NICAL VEN	TILATION		HEAT LOSS	
ROOM	ROOM NAME	AREA	CODE 403.3	CODE 403.3	ACT	UAL PROV	IDED	EXHAUST	BASED ON	HEATING PROVIDED
NUMBER		SQ FT	FRESH AIR	EXHAUST	SUPPLY FRESH RE-		RETURN	EXHAUST	ASHRAE	
	NEW OFFICE AREA									
001	VESTIBULE	94	14		150	50	100		3290	RTU-1
002	MANAGER RM1	172	4		150	50	100		6020	RTU-1
003	MANAGER RM2	158	4		150	50	100		5530	RTU-1
004	OPEN OFFICE	1185	30		1250	396	1000		41475	RTU-1
005	CONFERENCE RM	375	94		400	132	300		13125	RTU-1
006	CEO OFFICE	580	14		500	165	400		20300	RTU-1
007	LUNCH RM	346	62	242	250	100		250	12110	RTU-1
008	REC. ROOM	588	<del>1</del> 76		500	165			20580	RTU-1
009	CORRIDOR	94	NR							RTU-1
010	TOILET 1	120	NR	140				150		RTU-1
011	TOILET 2	116	NR	140				150		RTU-1
012	PRIVATE BATH	48	NR	70	50			150		RTU-1
013	COMPUTER RM	84	25		100	33		150	2940	RTU-1
	TOTAL	3960	398	592	3500	1155	2000		125370	168,000

## MECHANICAL NOTES:

1. ALL MECHANICAL WORK SHALL BE INSTALLED IN STRICT ACCORDANCE WITH PROPER REQUIREMENTS, STATE, LOCAL AND FEDERAL CODES, LAWS AND REGULATIONS.

2. PROVIDE AND INSTALL HEATING/COOLING THERMOSTATS AS SHOWN ON PLANS, SUBMIT AND REVIEW WITH ARCHITECT PRIOR TO CONSTRUCTION. ALL CONTROLS SHALL BE PROVEN BY ACTUAL FIELD TESTING IN THE PRESENCE OF THE ARCHITECT OR HIS REPRESENTATIVE.

3. CONTRACTOR TO VERIFY THAT ALL MECHANICAL UNITS, PLUMBING FIXTURES AND APPLIANCES CAN BE DELIVERED AND INSTALLED ON THE SITE AND ACCESSED FOR MAINTENANCE AND REPAIR AS WELL AS ACCEPTING THE WORK OF OTHER TRADES.

4. ALL SUPPLY /RETURN DUCTWORK TO BE GALVANIZED DUCTWORK TO BE IN ACCORDANCE WITH SMACNA AND BOCA CODES. PROVIDE BALANCING DAMPERS AT EACH BRANCH DUCT TAKE-OFF FROM MAIN DUCTWORK, PROVIDE LOCKING DEVICES FOR EACH DAMPER. AIR IN ALL ROOMS TO HEATED TO AN INSIDE TEMPERATURE OF 70 DEGREES FAHRENHEIT WHEN THE OUTSIDE TEMPERATURE IS -10 DEGREES FAHRENHEIT.

5. INSULATE SUPPLY DUCTS IN UNCONDITIONED PLENUM W/2" BATT INSULATION. FLEXIBLE AIR DUCTS SHALL BE A MAXIMUM OF 5'-0" IN LENGTH.

ALL SUPPLY OPENINGS TO BE A MINIMUM OF 10'-0" FROM ANY AND ALL EXHAUST OPENINGS. NOISE AT THE LOT LINE SHALL NOT EXCEED 55 DECIBLES ON THE "A" SCALE.

6. ALL FLUES SHALL BE CLASS "B" AND EXTEND 4'-0" ABOVE ROOF. SMOKE DETECTORS AND CARBON MONOXIDE DETECTORS ARE SHOWN ON DRAWINGS.

7. ALL FRESH AIR INTAKE OPENINGS SHALL BE A MIN. OF 10'-0" AWAY FROM ANY EXHAUST OR POINT OF CONTAMINATED DISCHARGE. ALL EXHAUST FANS TO BE AS MFD. BY OWNER, ALL GRILLES AND REGISTERS TO BE BY TITUS OR APPROVED. ALL GRILLES MAX 9" FROM WALL. GAS PIPING GREATER THAN 2" INSIDE DIAMETER OR CARRYING MORE THAN 5 POUNDS(PSIG) SHALL BE SCHEDULE 40 BLACK PIPE WITH STANDARD WELLED FITTINGS.

# 11/15/2021 CORRECTION NOTES

SCALE : 1" = 1'-0"

 $\frac{15/2021 \text{ CORRECTION NOTES}}{17}$ 

SPECIAL NOTE:
(1) SMOKE DETECTORS SHALL BE INSTALLED IN THE SUPPLY AIR SYSTEM WITH DESIGN CAPACITY OF GREAT THAN 2000 CFM (0.94m³/s) AND SHALL BE IN THE SUPPLY AIR DUCT OR PLENUM. DOWNSTREAM OF ANY HEATING COILS; COOLING COILS OR FAN AND PRIORI TO ANY TAKEOFFS OR DIVISION IN THE DUCT.

(2) ALL WORK SHALL CONFORM TO THE 2015 EDITION OF THE NATIONAL FULE GAS CODE AND 2015 INTERNATIONAL MECHANICAL CODE WITH ELGIN AMENDMENTS.

ELGIN IL 60124

2700 GALVIN DRIVE

WEI TAN 2425 S WENTWORTH AVE. CHICAGO IL 60616

PHONE: (312) 912-5798 EMAIL: twarchitect98@yahoo.com

LICENSE NO: 001-022013 EXPIRES: 11/30/2022

MEP ENGINEER 236 W ALEXANDER STREET CHICAGO IL 60616

PHONE: (312)720-8800
BILLY\_WANG68@HOTMAIL.COM
LICENSE NO: 062.068227
EXPIRES: 11 / 30 /2023

Z

INTERIOR BUILD-OUT A NEW OFFIC THE EXISTING WAREHOUSE 2700 GALVIN DRIVE ELGIN IL 60124

ISSUES DATE
ISSUED FOR PERMIT 10/08/2021
RE-ISSUED FOR PERMIT 11/15/2021

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062.068227


CELL: 312-720-8800

NEW OFFICE MECHANICAL PLAN & NOTES

POFESSIONAL

SHEET NUMBER

M1

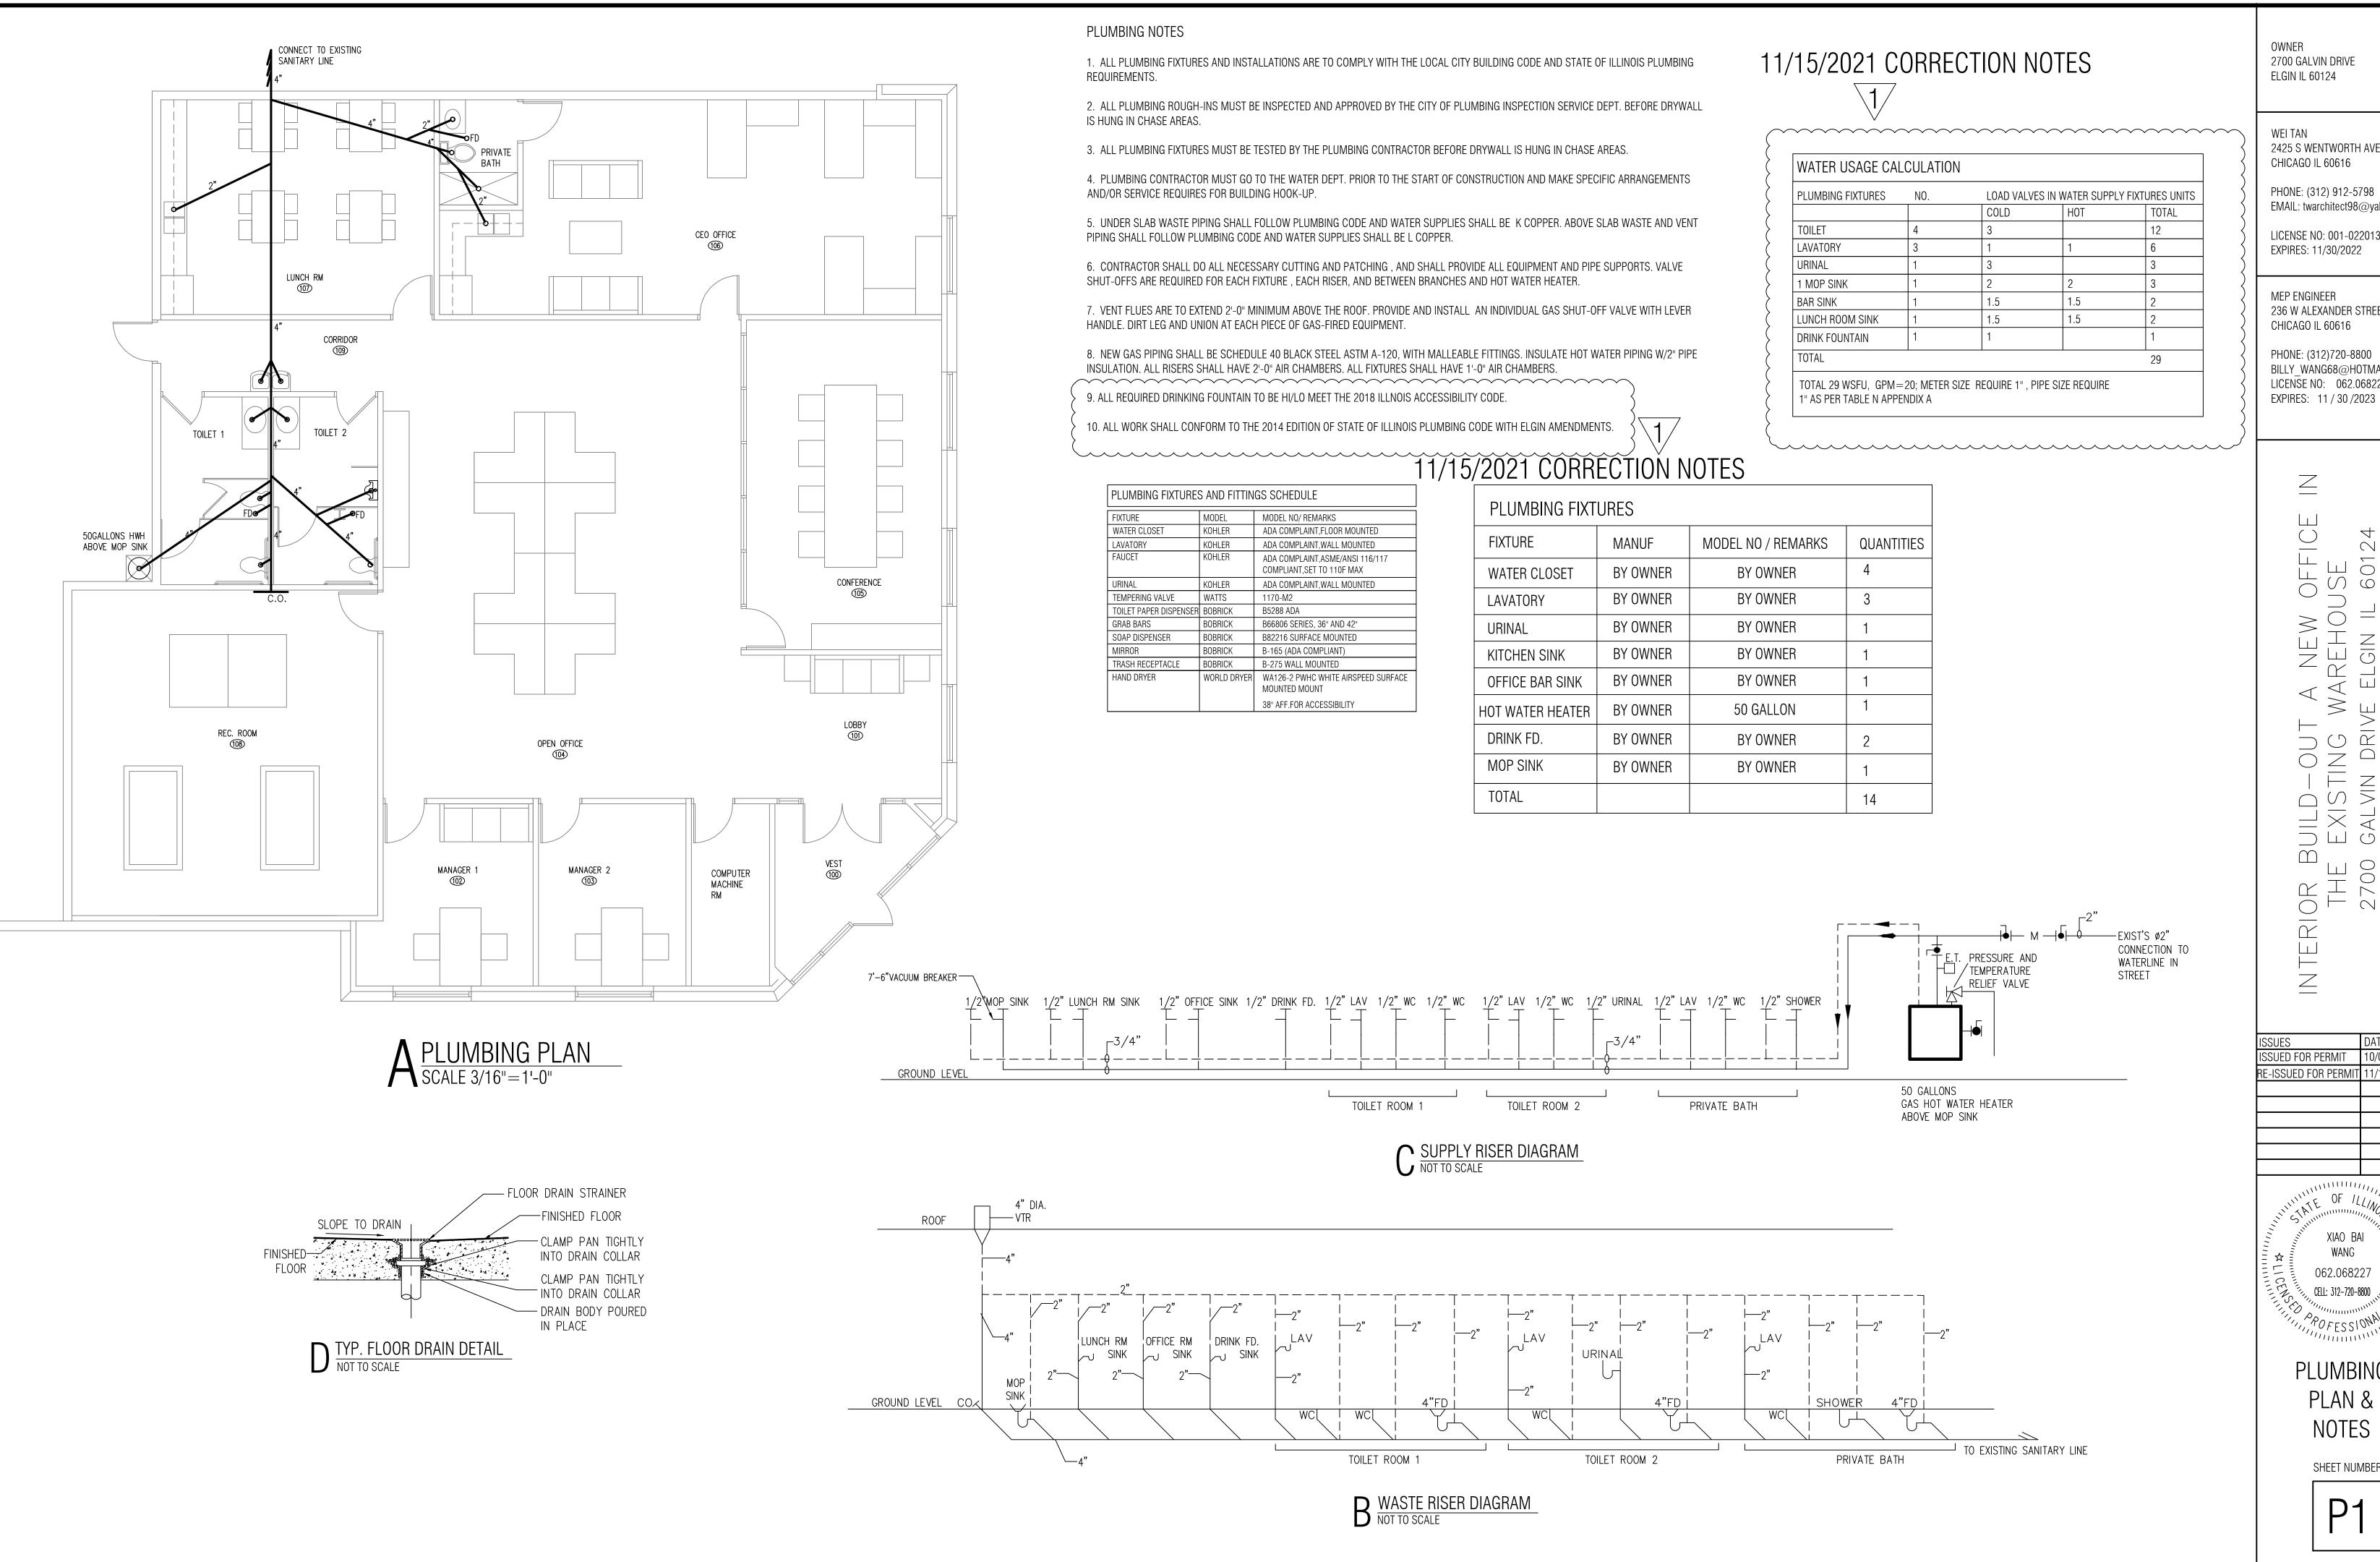

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> \_\_\_\_ BUIL EX O GAL INTERIOR B THE 2700

ISSUES	DATE
ISSUED FOR PERMIT	10/08/2021
RE-ISSUED FOR PERMIT	11/15/2021

OF ILLINO XIAO BAI 062.068227 CELL: 312-720-8800 POFESSIONAL

> **PLUMBING** PLAN &

